DEFINITIVE SITE PLAN

FOR

II4 AUSTIN STREET WORCESTER, MASSACHUSETTS 01609

RECORD APPLICANT:

POLAR VIEWS, LLC 89 WEST MAIN STREET UNIT 101 NORTHBOROUGH, MA 01532

RECORD OWNER:

POLAR VIEWS, LLC 89 WEST MAIN STREET UNIT 101 NORTHBOROUGH, MA 01532

LAND PLANNERS-CIVIL ENGINEERS:

J.M. GRENIER ASSOCIATES INC. 118 TURNPIKE ROAD SUITE 200 SOUTHBOROUGH, MA 01772 (508) 845–2500

LAND SURVEYORS:


GEO/NETWORK LAND SURVEY INC. 645 CHANDLER STREET SUITE 7 WORCESTER, MA 01610

ZONING DISTRICT: RESIDENCE, GENERAL (RG-5) OVERLAY DISTRICT: CROWN HILL LHD

CONTROL OF STORY OF S

8/21/24

INDEX DESCRIPTION 1 OF 9 COVER EXISTING CONDITIONS PLAN 2 OF 9 LAYOUT PLAN 3 OF 9 GRADING AND DRAINAGE PLAN 4 OF 9 5 OF 9 UTILITY PLAN 6 OF 9 LANDSCAPE PLAN 7 OF 9 EROSION & SEDIMENTATION CONTROL PLAN DETAIL PLAN 8 OF 9 DETAIL PLAN 9 OF 9

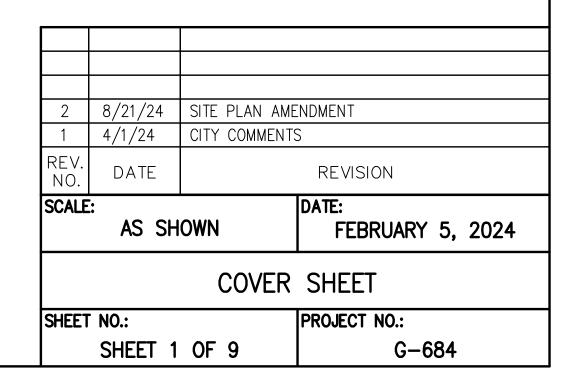


PLAN REFERENCES

PLAN BOOK 412 PLAN 100 PLAN BOOK 859 PLAN 99 PLAN BOOK 853 PLAN 74

> CITY OF WORCESTER PLANS NEWBURY STREET (H-32 6898) AUSTIN STREET (H-9435-1) QUINCY STREET (H-11 6986)

FOR REGISTRY OF DEEDS USE ONLY

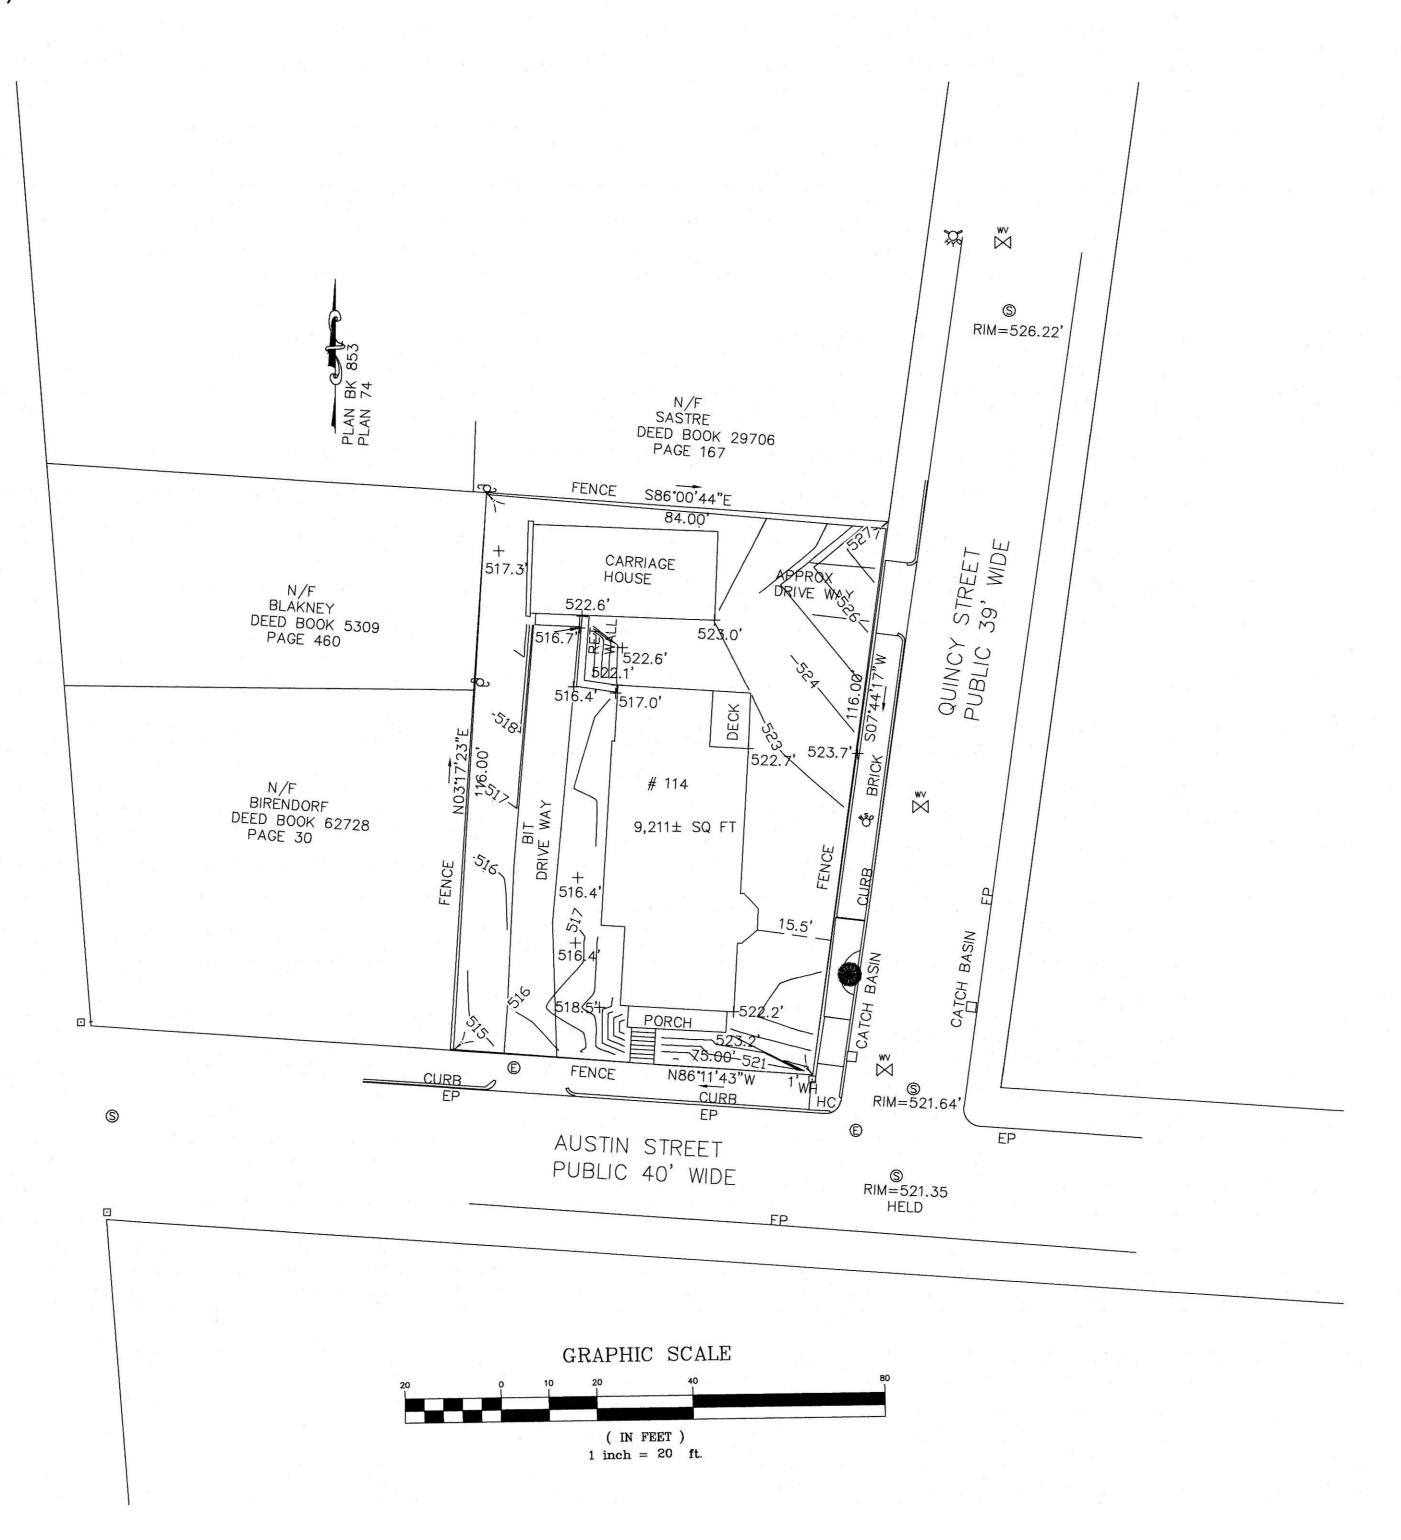




I HEREBY CERTIFY THAT THE PROPERTY LINES SHOWN ON THIS PLAN ARE THE LINES DIVIDING EXISTING OWNERSHIPS, AND THE LINES OF THE STREETS AND WAYS SHOWN ARE THOSE OF PUBLIC OR PRIVATE STREETS OR WAYS ALREADY ESTABLISHED AND THAT NO NEW LINES FOR DIVISION OF EXISTING OWNERSHIP OR FOR NEW WAYS ARE SHOWN,



Mary & Harryes



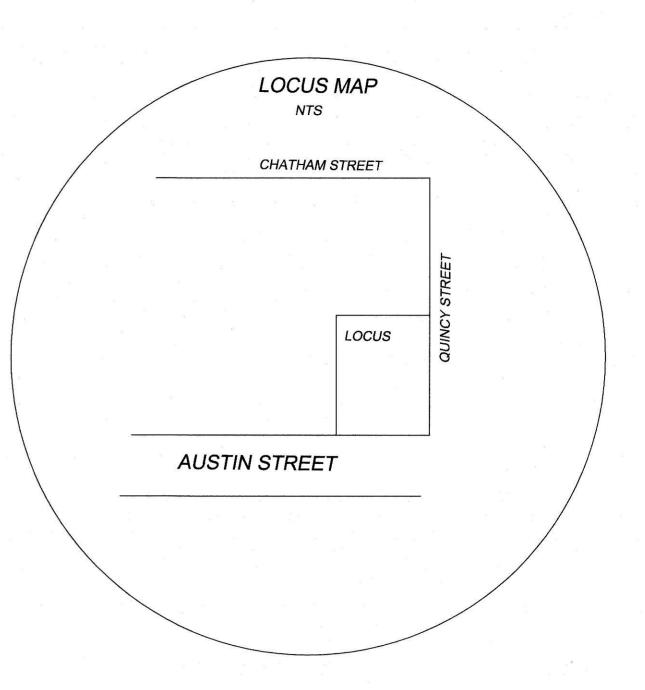

NOTES


- 1,) DATUM TAKEN FROM UTILITY PLAN FROM CITY OF WORCESTER CONTRACTOR TO CONFIRM DATUM
- 2.) CONSTRUCTION ON LOTS OR LAND IS SUBJECT TO ANY EASEMENTS, RIGHT OF WAYS, RESTRICTION RESERVATIONS OR LIMITATIONS ON RECORD
- 3.) UTILITIES SHOWN ARE FROM FIELD LOCATIONS
 IT SHALL BE THE RESPONSIBILITY OF THE DESIGN ENGINEER
 AND THE CONTRACTOR TO VERIFY THE SIZE, ELEVATION AND
 LOCATION, AND TO CONTACT "DIG-SAFE ST LEAST 72
 HOURS PRIOR TO ANY EXCAVATION, DEMOLITION OR
 CONSTRUCTION

PLAN OF LAND 114 AUSTIN STREET WORCESTER, MA

PREPARED FOR: DANIEL AND REBECCA YARNIE FEBRUARY 1, 2024 SCALE 1' = 20'

GEO / NETWORK LAND SURVEY, INC. 645 CHANDLER STREET SUITE 7 WORGESTER MASSACHUSETTS 01610

WORCESTER, MASSACHUSETTS 01610 508-755-7003 FAX 508-755-8003

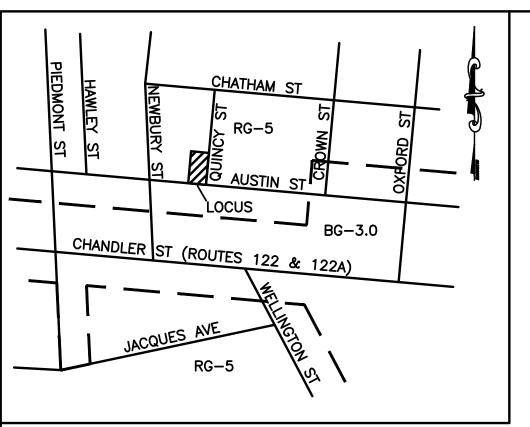

LOCUS: N.T.S.

ZONING SUMMARY

CURRENT ZONE: RESIDENCE, GENERAL (RG-5) OVERLAY ZONE: CROWN HILL LHD

	REQUIRED			PROPOSED		
	REQUIRED	SINGLE FAMILY	EXISTING	SINGLE FAMILY		
	MFD LOW RISE	<u>ATTACHED</u>	MFD LOW RISE	<u>ATTACHED</u>		
MIN. LOT AREA	8,000 SQ.FT.(1)	11,000 SQ.FT.(2)	9,211 SQ.FT.	9,211 SQ.FT.**		
LOT REGULARITY FACTOR(3)	0.4	0.4	0.964	0.964		
MIN. FRONTAGE	65'	100'	116.00'	116.00'		
MIN. FRONT YARD SETBACK	15'	15'	15.5'	8.8'**		
MIN. EXTERIOR SIDE YARD SETBACK	10'	10'	7.3'*	2.0'**		
MIN. SIDE YARD SETBACK	10'	8'	37.5'	5.3'**		
MIN. REAR YARD SETBACK	15'	15'	29.1'	36.3'		
MIN. ACCESSORY SETBACK	5'	5'	4.6'*			
MAX. FRONT YARD IMPERVIOUS	50%	50%	5.1%	20.0%		
MAX. BUILDING COVERAGE			29.0%	34.4%		
MAX. BUILDING HEIGHT	50' (3+ STORIES)	35' (2+ STORIES)	3 STORIES	34'3" (2+ STORIES		
	, ,					

(1) 5,000 SQ.FT/FIRST D.U. + (1,000 SQ.FT/D.U.)*3 = 8,000 SQ.FT. (2) 2,200 SQ.FT/D.U.*5 = 11,000 SQ.FT. (3) R=16*A/P^2, WHERE A=AREA AND P=PERIMETER


* PRE-EXISTING NONCONFORMING


** VARIANCE GRANTED FROM ZONING BOARD OF APPEALS

PARKING SPACE REQUIREMENTS

RESIDENTIAL: 2/D.U X 5 UNITS = REQUIRED PROPOSED 10 SPACES 5 SPACES***

*** VARIANCE GRANTED FROM ZONING BOARD OF APPEALS

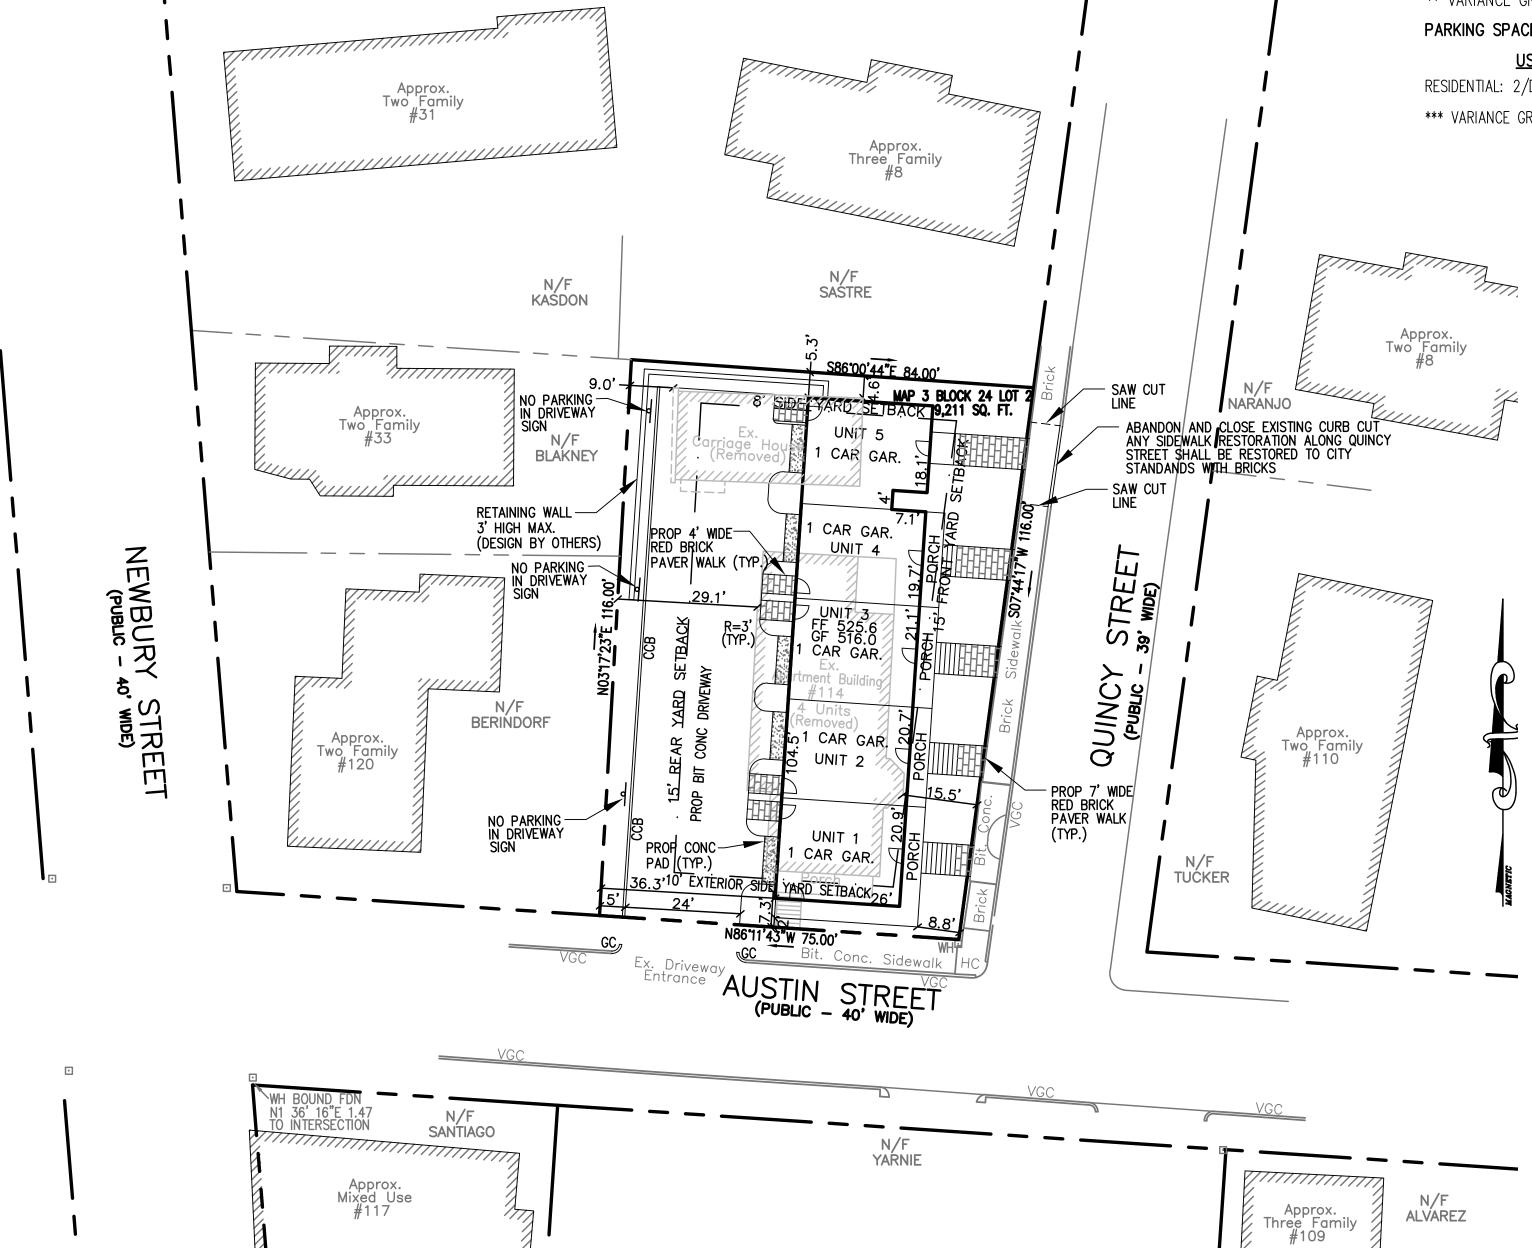


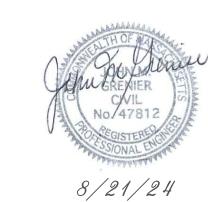

LEGEND:	
	 EXISTING PROPERTY LINE
— —520 — —	— EXISTING CONTOUR — HIGH
<u> </u>	 EXISTING CONTOUR - LOW
 520 	- PROPOSED CONTOUR - HIGH
518	- PROPOSED CONTOUR - LOW
	- EXISTING EDGE PAVEMENT
	EXISTING CURB
	- PROPOSED EDGE OF PAVEMENT
	= PROPOSED CURB
D	EXISTING DRAIN LINE
D	- PROPOSED DRAIN LINE
	- EXISTING WATER LINE
	- PROPOSED WATER LINE
s	= EXISTING SEWER LINE
s	- PROPOSED SEWER LINE
	 PROPOSED EROSION CONTROL

NOTE

WRTA ROUTES 6 & 7 ARE LOCATED WITHIN WALKING DISTANCE TO THE SUBJECT PROPERY (AT CHANDLER/PEIDMONT, CHANDLER WELLINGTON, CHANDLER/QUEEN).

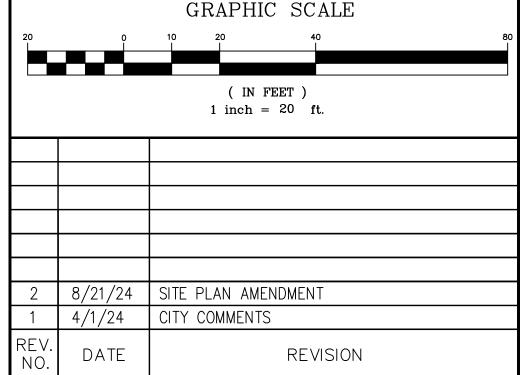

TITLE

DEFINITIVE SITE PLAN
FOR
114 AUSTIN STREET
WORCESTER, MASSACHUSETTS 01609

PREPARED FOR:

POLAR VIEWS, LLC 89 WEST MAIN STREET UNIT 101 NORTHBOROUGH, MASSACHUSETTS 01532

PROPERTY OWNER:

POLAR VIEWS, LLC 89 WEST MAIN STREET UNIT 101 NORTHBOROUGH, MASSACHUSETTS 01532

PREPARED BY:

J.M. GRENIER ASSOCIATES INC.

118 TURNPIKE ROAD SUITE 200
SOUTHBOROUGH, MASSACHUSETTS 01772

No.: (508) 845-2500 jmgrenier@townisp.com


TELE NO.: (508) 845-2500 **SCALE:**

1" = 20'

TE: FEBRUARY 5, 2024

LAYOUT PLAN


SHEET NO.: SHEET 3 OF 9 PROJECT NO.: G-684

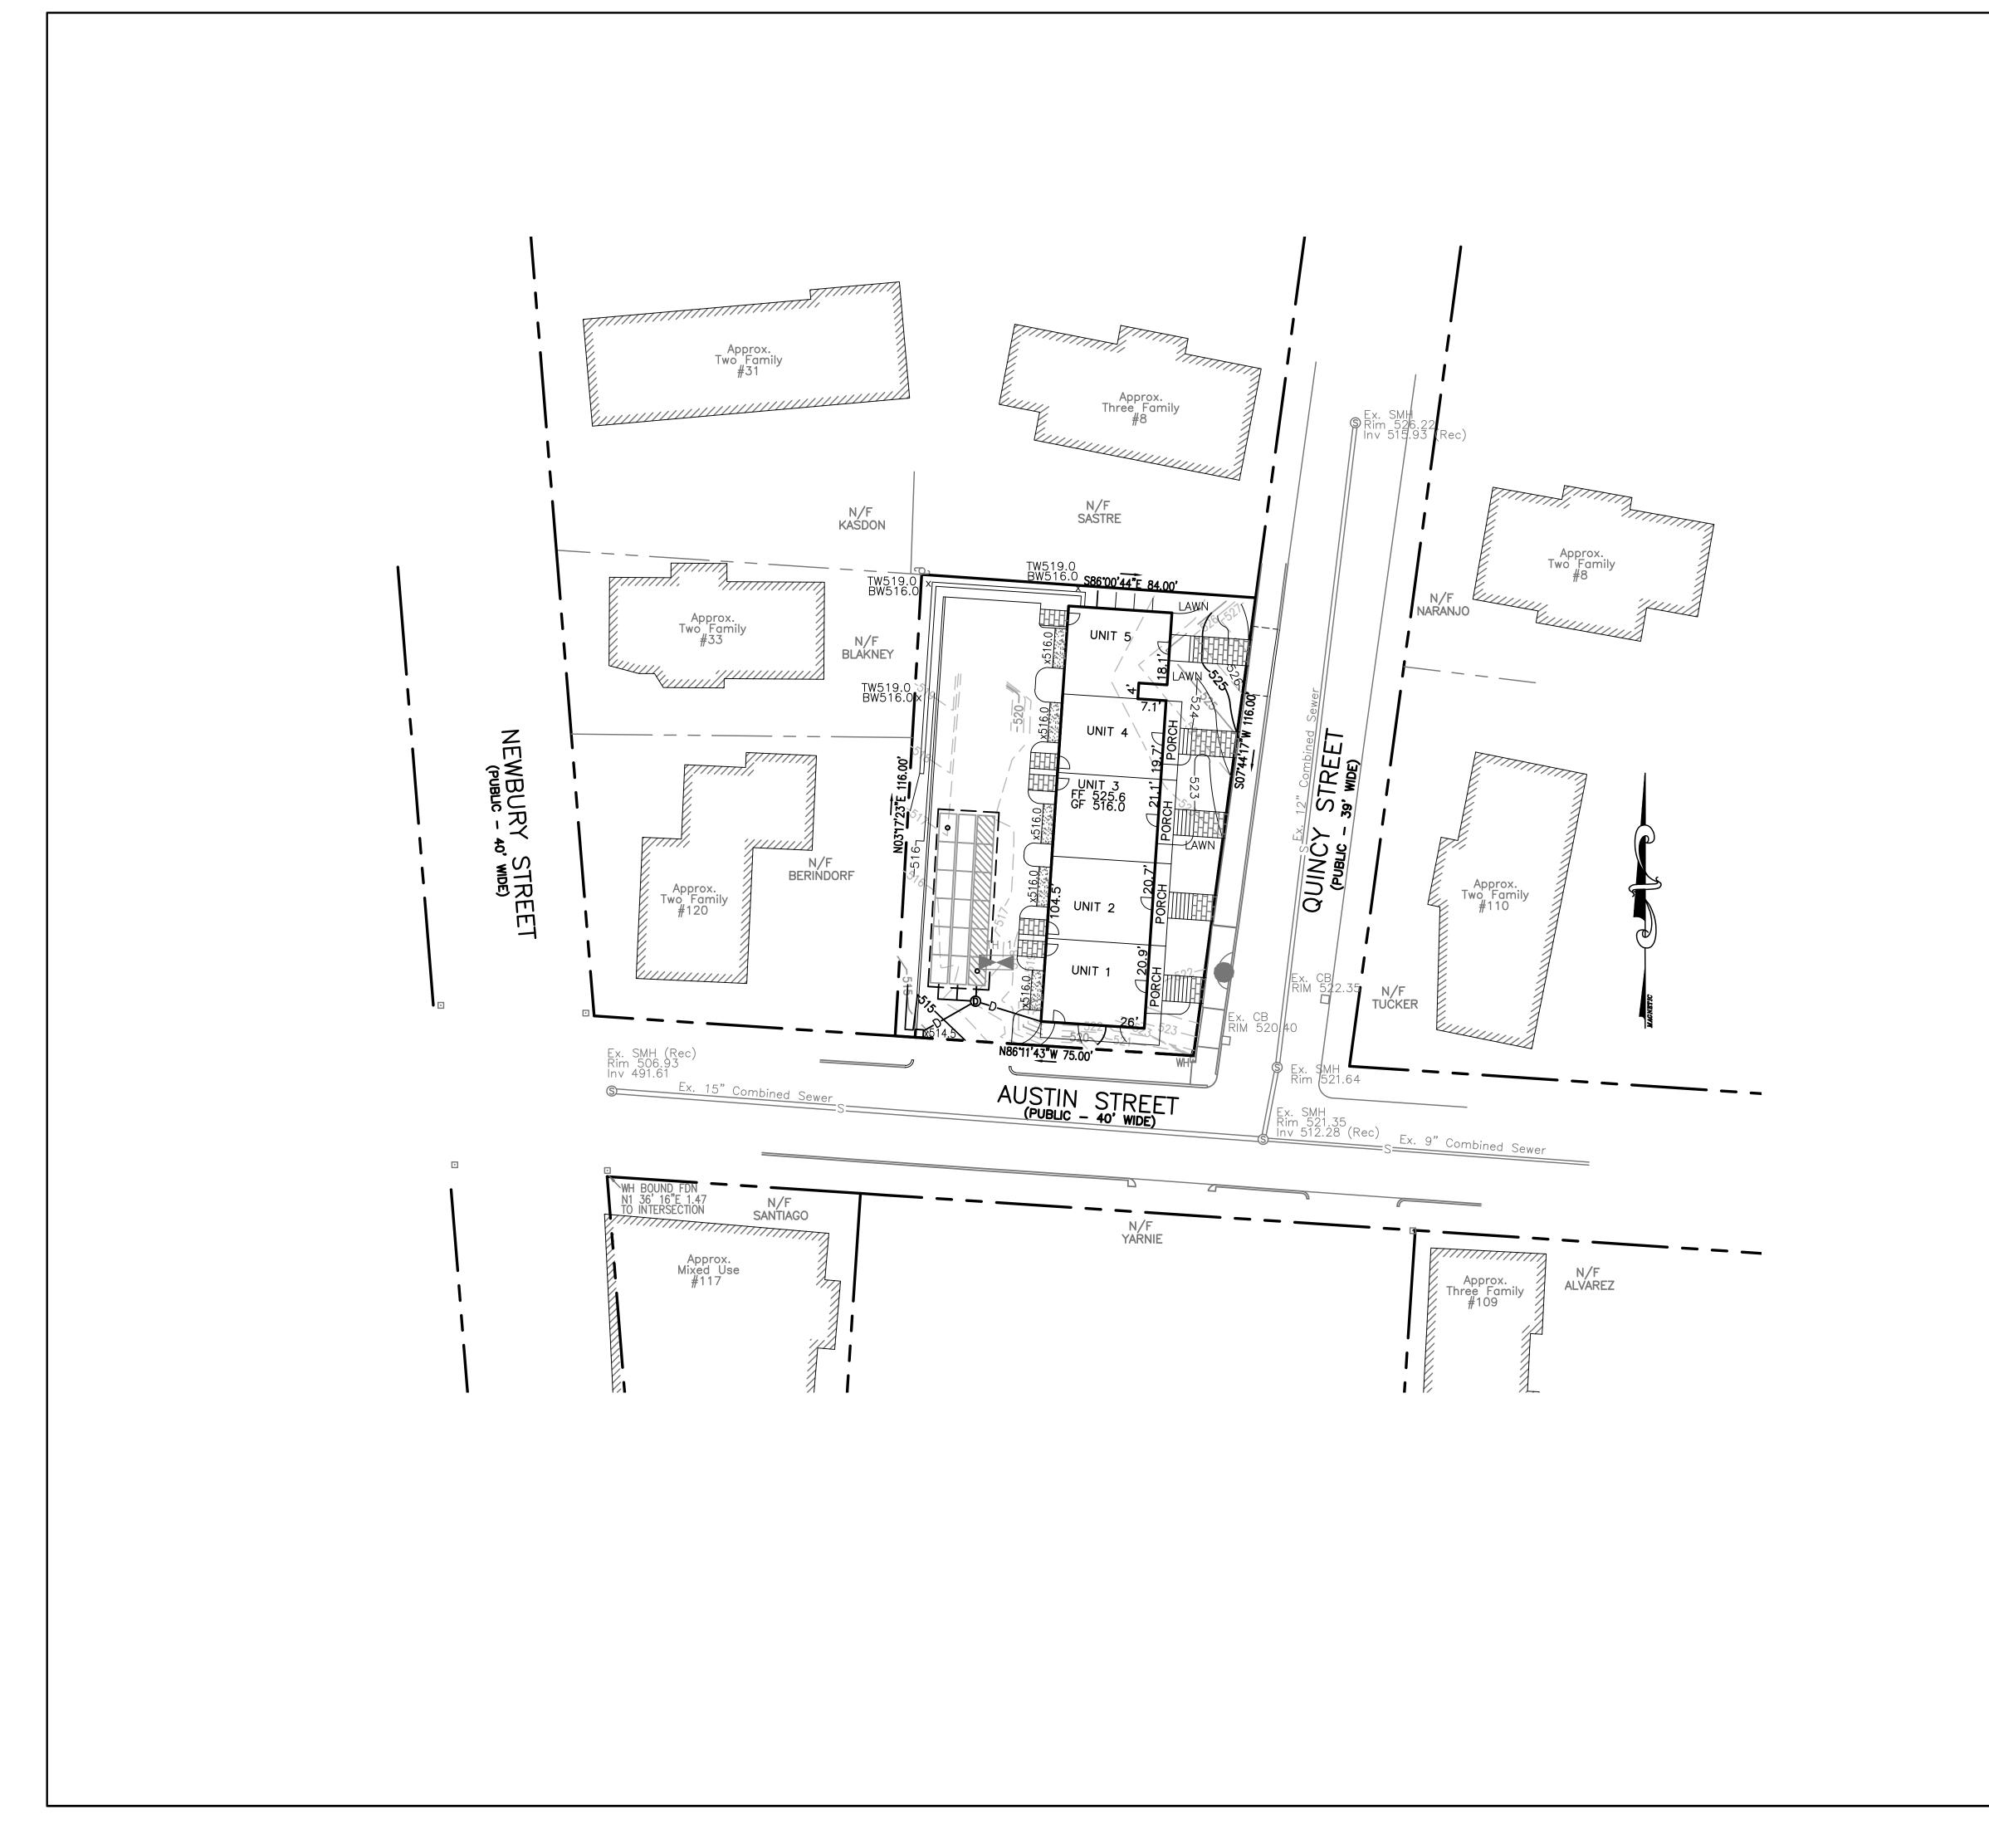

TEST HOLE DATA ELEV. 517.0 0-24" FILL 24-126" C LS ESHGW >126" (ELEV. 506.5)

LEGEND:	
	EXISTING PROPERTY LINE
— —520 — —	EXISTING CONTOUR - HIGH
— — 518 — — —	EXISTING CONTOUR - LOW
520	PROPOSED CONTOUR - HIGH
 518 	PROPOSED CONTOUR - LOW
	EXISTING EDGE PAVEMENT
	EXISTING CURB
	PROPOSED EDGE OF PAVEMENT
	PROPOSED CURB
D	EXISTING DRAIN LINE
D	PROPOSED DRAIN LINE
	EXISTING WATER LINE
——————————————————————————————————————	PROPOSED WATER LINE
===== S =====	EXISTING SEWER LINE
s	PROPOSED SEWER LINE
	PROPOSED EROSION CONTROL

- EXISTING CONDITIONS SURVEY BY GEO/NETWORK LAND SURVEY INC. 645 CHANDLER STREET SUITE 7 WORCESTER, MA 01610.
- 2. REFERENCE CITY OF WORCESTER ASSESSOR'S MAP 3 BLOCK 24 LOT 2.
- 3. REFERENCE WORCESTER REGISTRY OF DEEDS BOOK 68720 PAGE 1.
- 4. DATUM IS NAVD88.
- 5. EXISTING SOILS ON SITE ARE URBAN LAND.

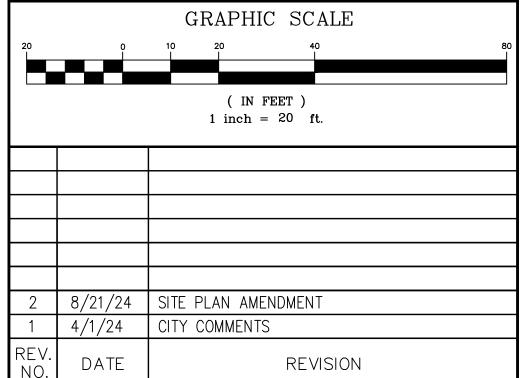

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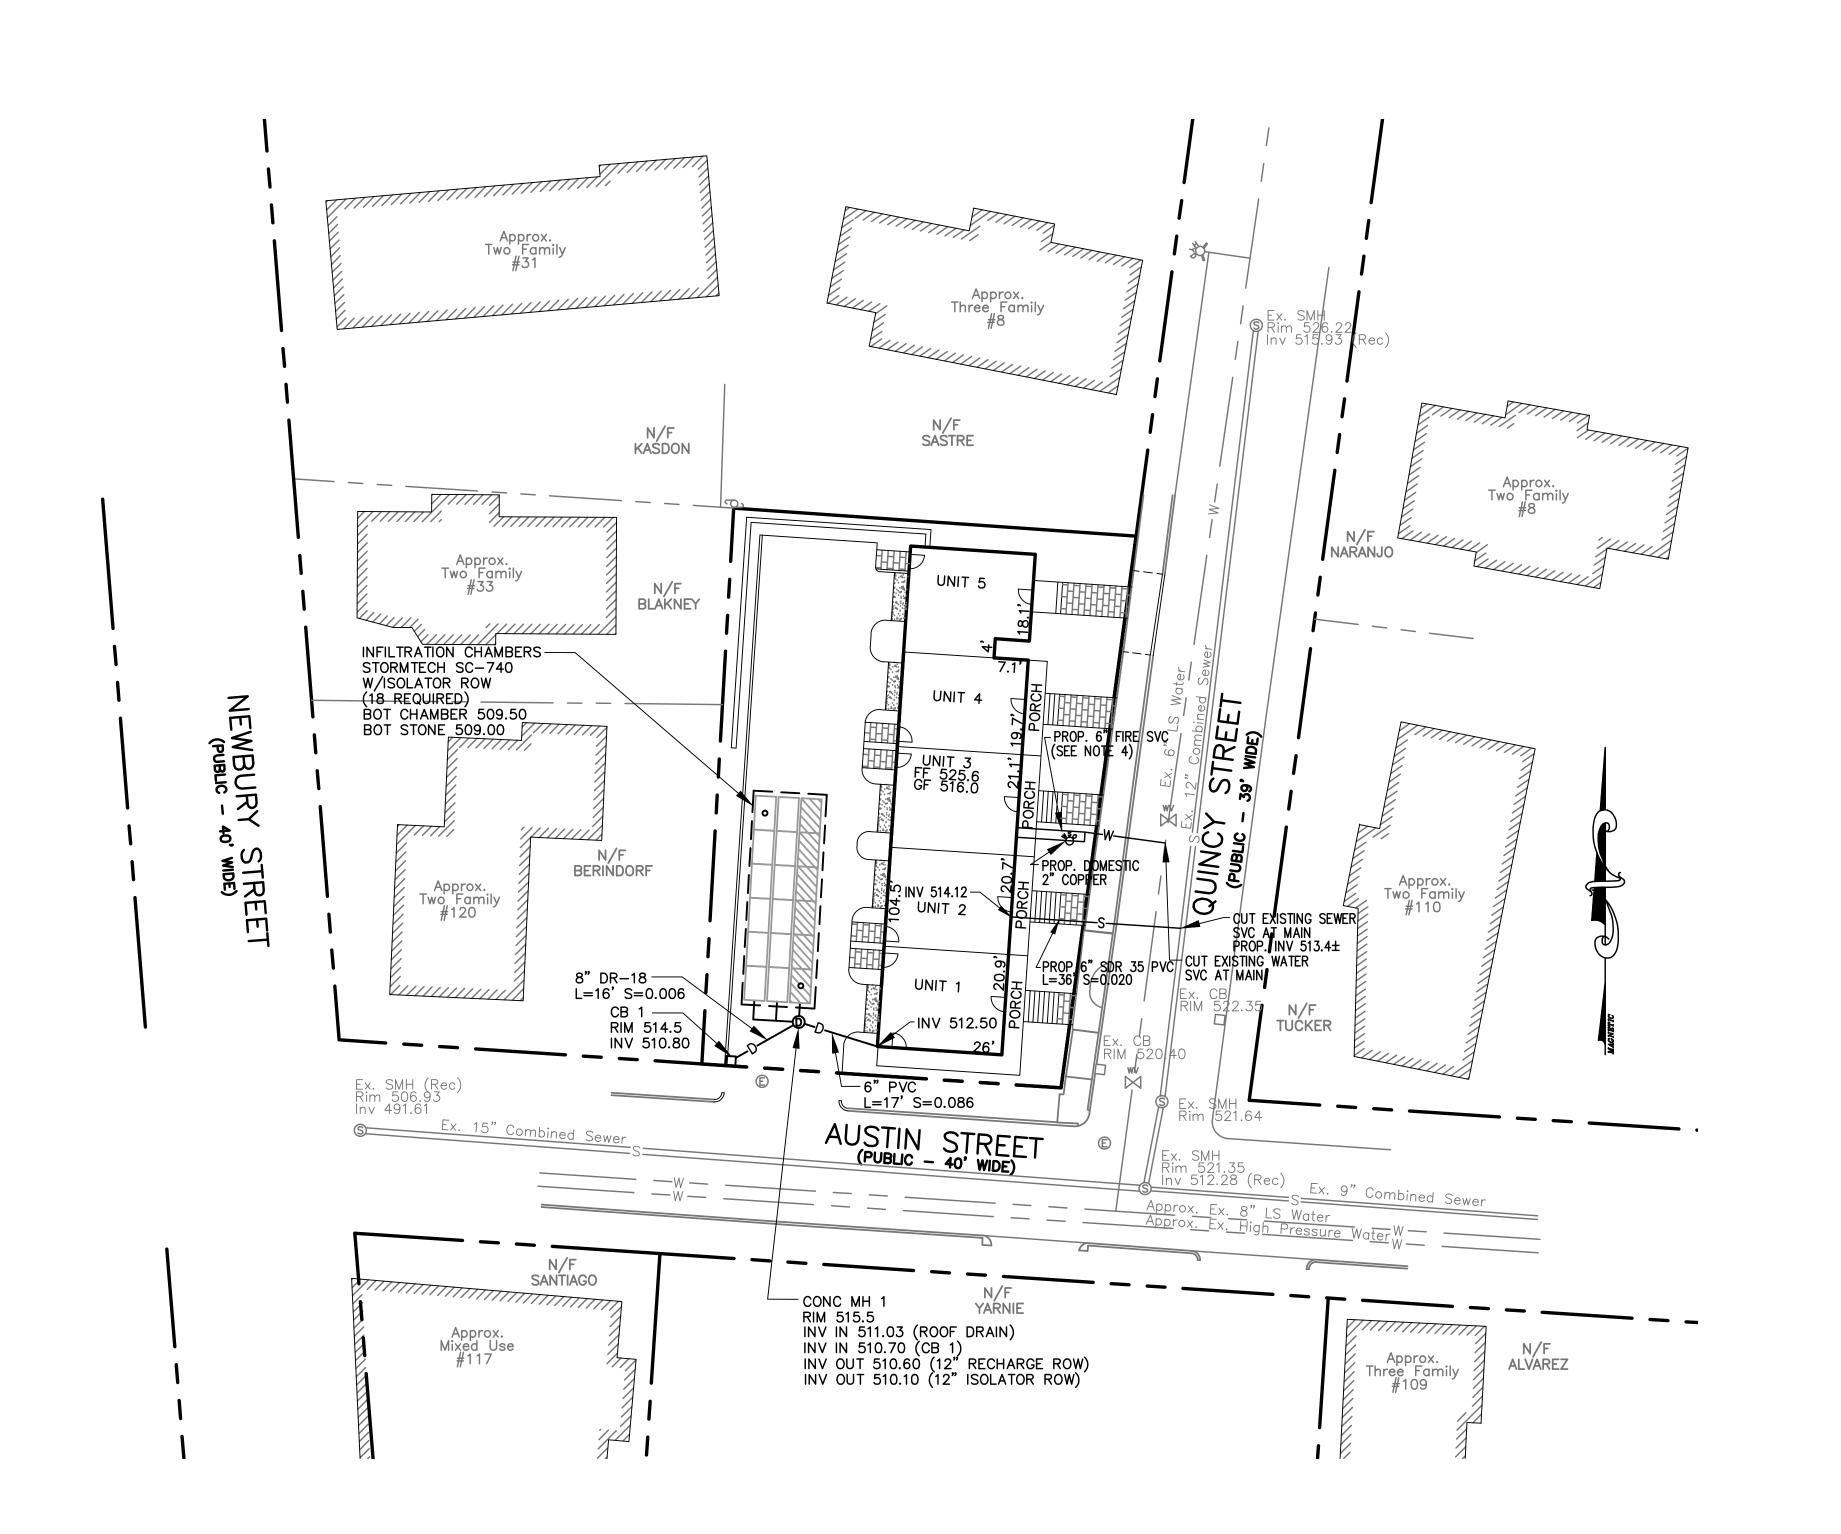
FEBRUARY 5, 2024


SHEET NO.: SHEET 4 OF 9

1" = 20'

GRADING AND DRAINAGE PLAN PROJECT NO.:

G-684



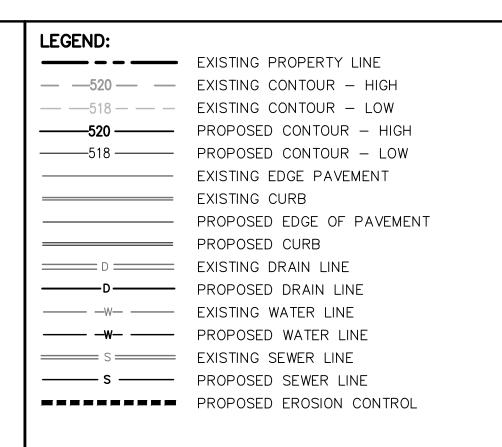

NOTES

- 1. ALL TRENCHES WITHIN QUINCY STREET SHALL BE BACKFILLED AS REQUIRED BY THE CITY OF WORCESTER.
- 2. EXISTING CATCH BASINS WITHIN 100' OF THE PROPERTY MUST BE PROTECTED WITH INLET PROTECTION AT ALL TIMES UNTIL THE SITE IS FULLY STABILIZED.
- 3. SEWER SHALL BE INSTALLED WITH A MINIMUM HORIZONTAL SEPARATION OF 10 FEET FROM ALL WATER SUPPLY LINES. WHEN A 10 FOOT SEPARATION CANNOT BE MAINTAINED THE WATER MAIN SHALL BE INSTALLED IN A SEPARATE TRENCH ABOVE THE SEWER WITH AN 18 INCH VERTICAL SEPARATION BETWEEN THE CROWN OF THE SEWER AND THE INVERT OF THE WATER MAIN. ADEQUATE VERTICAL SEPARATION OF WATER/SEWER CROSSING SHALL BE CONFIRMED.
- 4. SIZE OF FIRE SERVICE LINE TO BE DETERMINED BY FIRE FLOW REQUIREMENTS
- 5. DOMESTIC WATER LINE SHALL BE SLEEVED UNDER FOOTING WITH 2" MINIMUM DIAMETER CONDUIT.
- 6. CONTRACTOR SHALL CONTACT DIG SAFE AT 1-888-344-7233 72 HOURS PRIOR TO COMMENCING ANY EXCAVATION.
- CONTRACTOR SHALL FIELD VERIFY DIMENSIONS AND CONDITIONS PRIOR TO THE COMMENCEMENT OF CONSTRUCTION.
- 8. SHOULD FIELD CONDITIONS VARY FROM THOSE SHOWN, ENGINEER SHALL BE CONTACTED PRIOR TO COMMENCEMENT OF SITE CONSTRUCTION.

20	0	10 20 40 80 (IN FEET) 1 inch = 20 ft.
2	8/21/24	SITE PLAN AMENDMENT
1	4/1/24	CITY COMMENTS
REV. NO.	DATE	REVISION

GRAPHIC SCALE

TIT

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FOR
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TELE NO.: (508) 845-2500 **SCALE:**

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TE: FEBRUARY 5, 2024


G-684

jmgrenier@townisp.com


UTILITY PLAN

SHEET NO.: PROJECT NO.: G-

Odviden Grevier CVIL No. 47812 SSIONAL THE 8/21/24

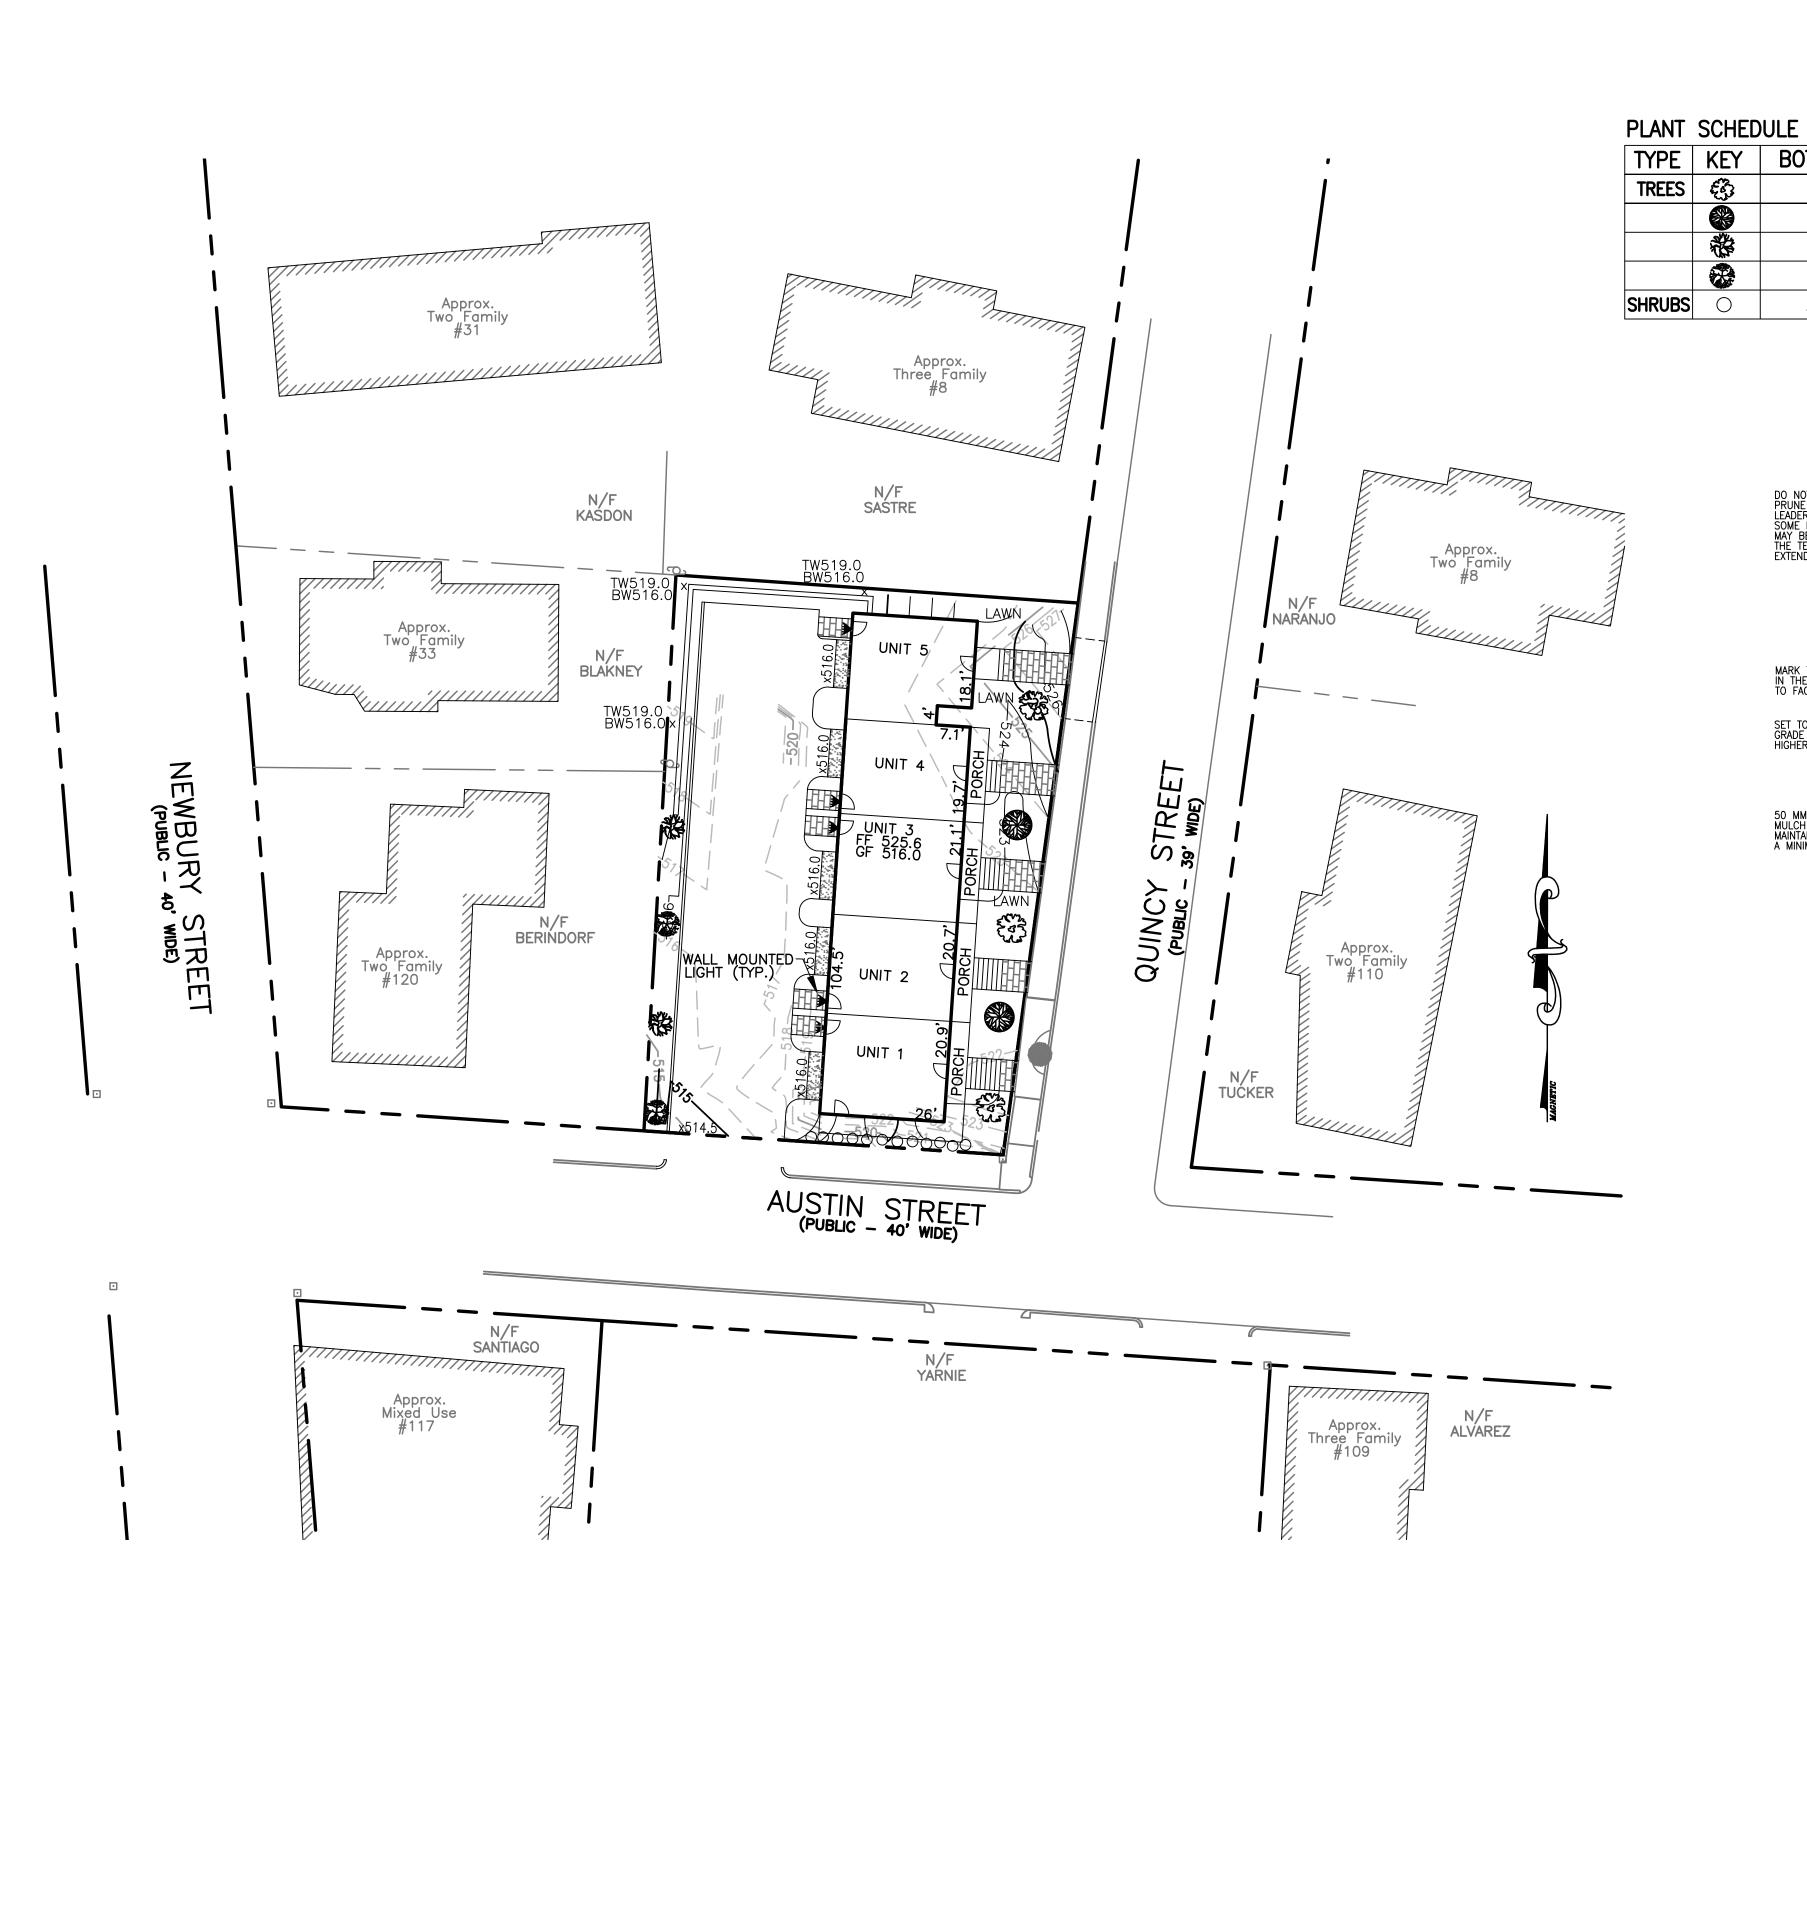

TYPE	KEY	BOTANICAL NAME	COMMON NAME	SIZE	CONDITION	QTY	
TREES	E	Quercus palustris	Pin Oak	3 1/2" cal.	B&B	3	
		Cornus florida	Flowering Dogwood	3 1/2" cal.	B&B	2	
	泰	Tilia tomentosa	Silver Linden	2 1/2" cal.	B&B	2	
		Juniperous chinensis	Chinese Juniper	6-7'	B&B	2	
SHRUBS	0	Andropogon virginicus	Broomsedge	1 gal.	B&B	12	

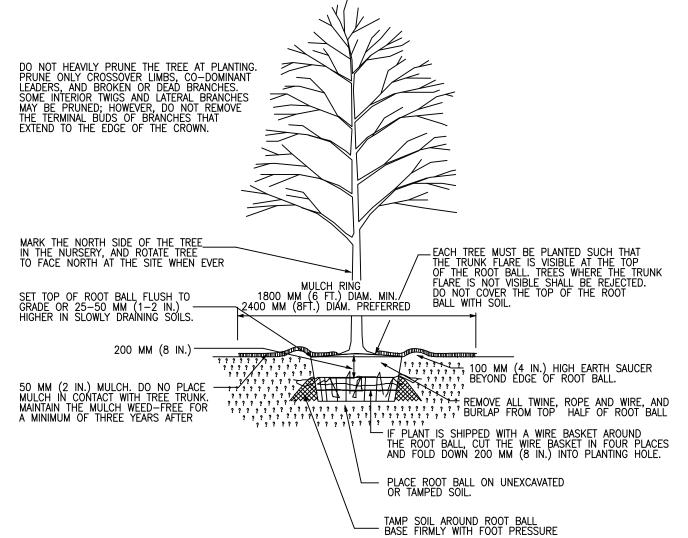

TREE PLANTING DETAIL - B&B TREES



LEGEND:	
	EXISTING PROPERTY LINE
— —520 — —	EXISTING CONTOUR - HIGH
— —518 — —	EXISTING CONTOUR - LOW
 520 	PROPOSED CONTOUR — HIGH
 518 	PROPOSED CONTOUR - LOW
	EXISTING EDGE PAVEMENT
	EXISTING CURB
	PROPOSED EDGE OF PAVEMENT
	PROPOSED CURB
D	EXISTING DRAIN LINE
D	PROPOSED DRAIN LINE
	EXISTING WATER LINE
——————	PROPOSED WATER LINE
s	EXISTING SEWER LINE
—— s ——	PROPOSED SEWER LINE
	PROPOSED EROSION CONTROL

- ALL PLANTINGS SHALL BE ASIAN LONGHORNED BEETLE (ALB) AND EMERALD ASH BORER (EAB) RESISTANT.
- PLANTINGS SHOWN ARE SUBJECT TO AVAILABILITY AND MAY BE EXCHANGED FOR OTHER ALB AND EAB RESISTANT SPECIES IF NECESSARY DUE TO SUPPLY LIMITATIONS.
- SNOW STORAGE SHALL NOT BE LOCATED WITHIN ANY REQUIRED PARKING SPACES OR LANDSCAPED BUFFERS AND SHALL NOT IMPEDE VISIBILITY. ONCE DESIGNATED SNOW STORAGE AREAS EXCEED CAPACITY SNOW SHALL BE REMOVED FROM THE SITE.
- LIGHTING SHALL BE WALL MOUNTED AND RESIDENTIAL IN STYLE. ALL LIGHTING SHALL BE DARK SKY COMPLIANT WITH SHIELDING TO PREVENT SPILLOVER AND A MAX TEMPERATURE OF 3000K.

GRAPHIC SCALE (IN FEET) 1 inch = 20 ft.8/21/24 SITE PLAN AMENDMENT 4/1/24 CITY COMMENTS REVISION

DEFINITIVE SITE PLAN 114 AUSTIN STREET WORCESTER, MASSACHUSETTS 01609

PREPARED FOR:

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PROPERTY OWNER:

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PREPARED BY:


J.M. GRENIER ASSOCIATES INC. 118 TURNPIKE ROAD SUITE 200 SOUTHBOROUGH, MASSACHUSETTS 01772 jmgrenier@townisp.com

TELE NO.: (508) 845–2500 SCALE: 1" = 20'

FEBRUARY 5, 2024

LANDSCAPE PLAN

SHEET NO.: SHEET 6 OF 9 PROJECT NO.: G-684

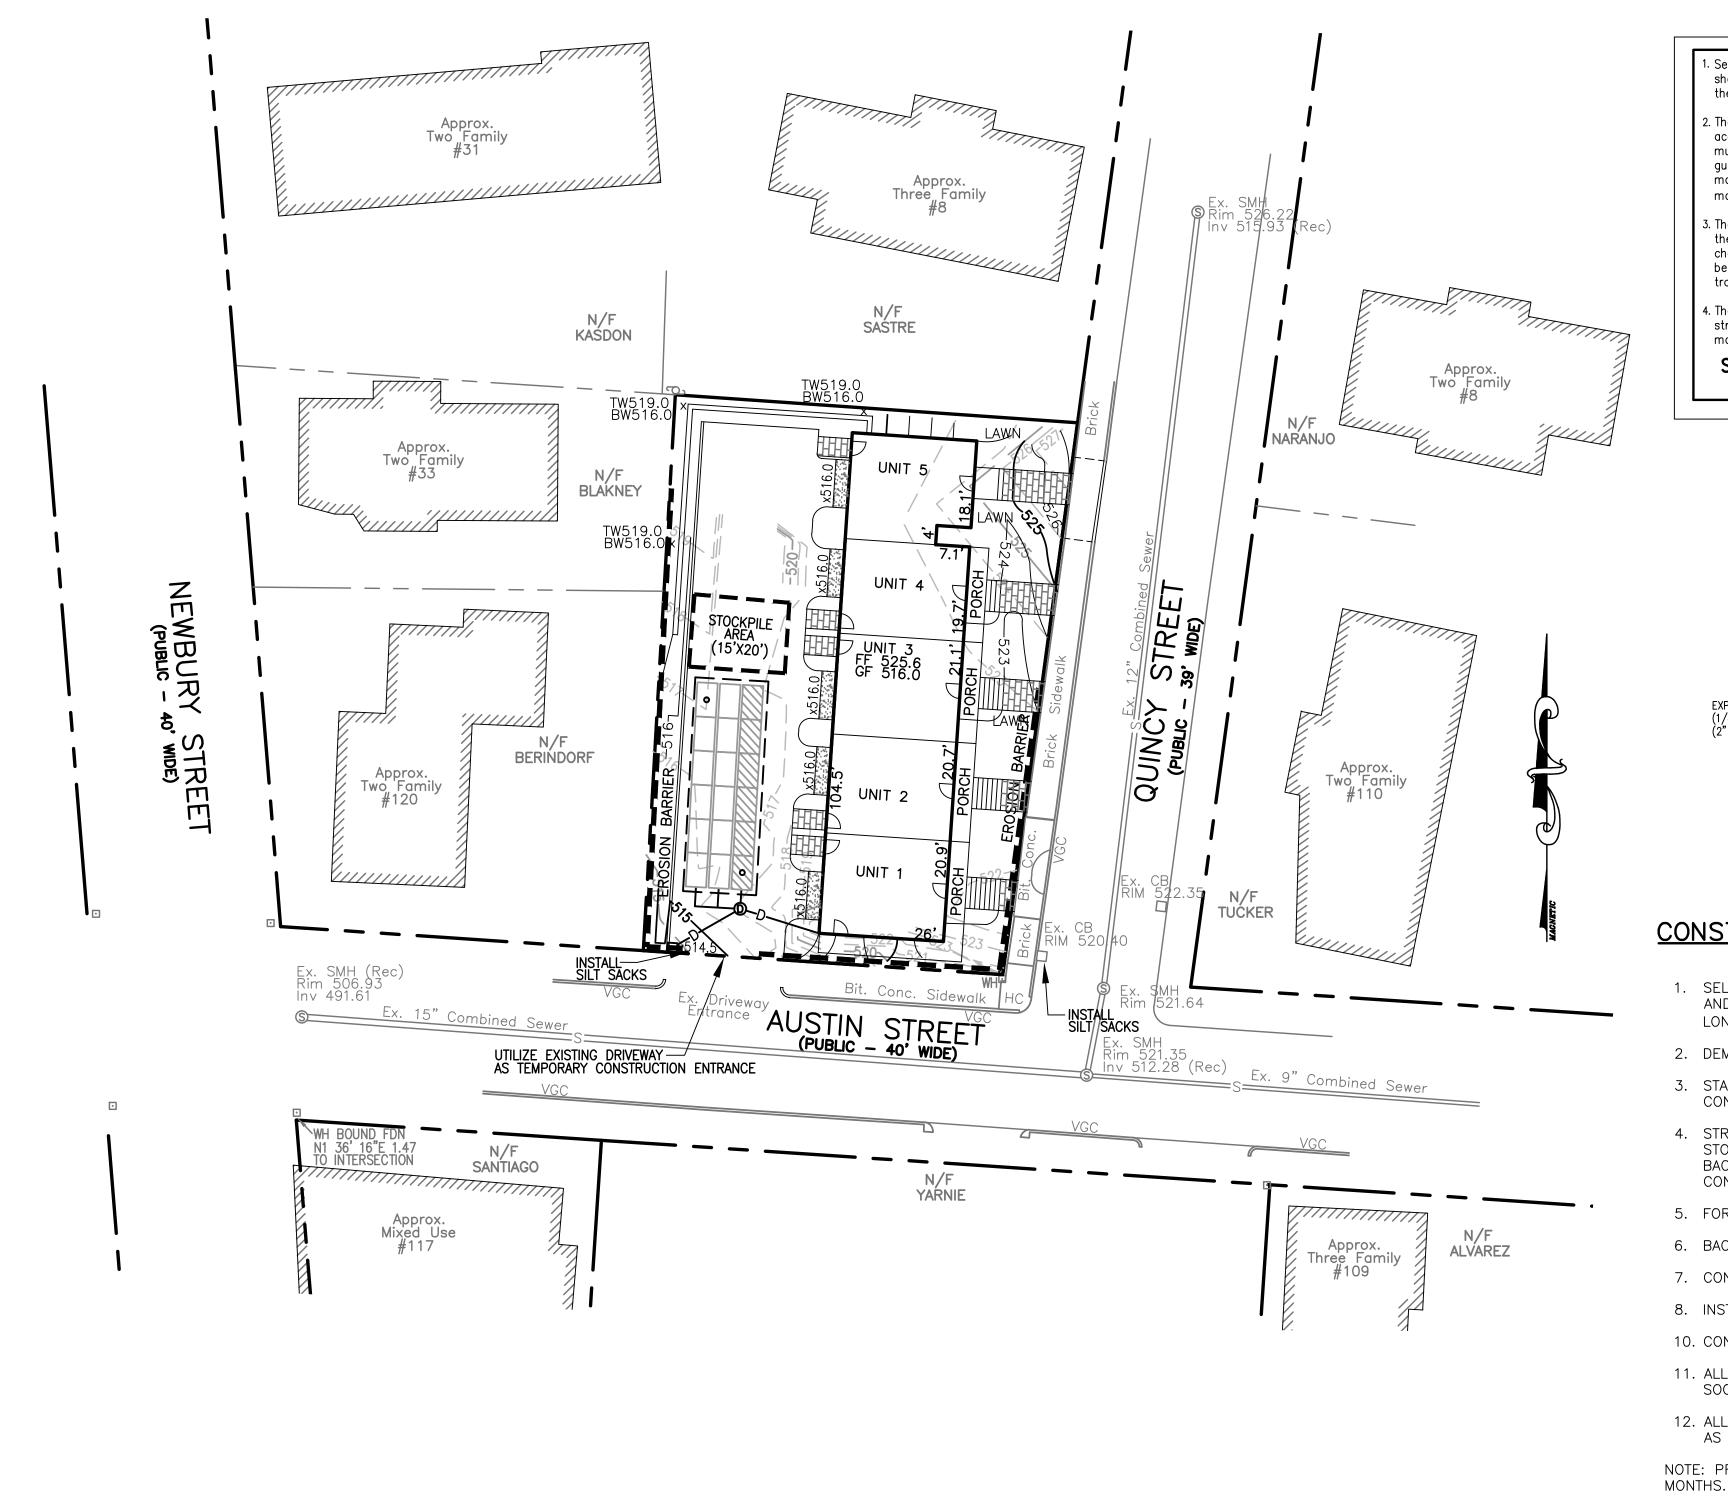


1. Seeding and repairs shall be performed as required. Sediment and debris shall be removed at least once a year, typically in early spring prior to the commencement of the growing season.

2. The catch basin shall be inspected annually. Unit shall be cleaned when accumulated sediments reach a depth of 6 inches. Accumulated sediment must be disposed of in accordance with applicable local state, and federal guidelines and regulations. The contractor will be responsible for the maintenance of the unit until such time as the site work is complete. The maintenance will then be the responsibility of the owner(s).

3. The infiltration chambers shall be inspected after every major storm for the first 3 months to ensure proper stabilization and function. The chambers shall be inspected once per year after that. Water levels should be inspected and recorded for several days after a major storm event to track infiltration capability.

4. The contractor will be responsible for the maintenance of all drainage structures and until such time as the site work is complete. The maintenance will then be the responsibility of the property owners.

STORMWATER COLLECTION & TREATMENT SYSTEM INSPECTION & MAINTENANCE GUIDELINES

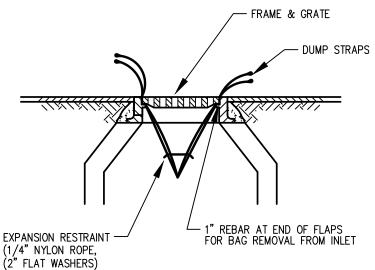

BAGS SHOULD BE CLEANED OUT AFER EVERY RAIN EVENT AND/OR AS NEEDED.

SILT SACK DETAIL

CONSTRUCTION SEQUENCING:

- 1. SELECTIVELY CUT TREES AND CLEAR BRUSH TO BE CHIPPED AND HAULED OFF SITE. NOTE THAT THE SITE IS IN THE ASIAN LONGHORNED BEETLE (ALB) REGULATED AREA.
- 2. DEMOLISH EXISTING APARTMENT BUILDING.
- 3. STAKE LOCATION OF AND INSTALL EROSION CONTROL BARRIER, CONSTRUCTION ENTRANCE AS DELINEATED ON SITE PLAN.
- 4. STRIP TOP AND SUBSOIL AS NECESSARY IN WORK AREA. STOCKPILE MATERIAL ON WEST PORTION OF LOT FOR BACKFILLING PURPOSES AT COMPLETION OF FOUNDATION CONSTRUCTION.
- 5. FORM AND POUR FOUNDATION FOR NEW BUILDING.
- 6. BACKFILL FOUNDATION AREAS AS NECESSARY
- 7. CONSTRUCT BUILDING.
- 8. INSTALL RECHARGE CHAMBERS
- 10. CONSTRUCT DRIVEWAY AND LOAM AND SEED DISTURBED AREAS.
- 11. ALL EXCESS MATERIALS TO BE REMOVED FROM THE SITE AS SOON AS PRACTICAL
- 12. ALL GRADED AREAS TO BE LANDSCAPED, LOAMED AND SEEDED AS SOON AS PRACTICAL TO REDUCE ANY POTENTIAL EROSION.

NOTE: PROCESSES AS DESCRIBED ABOVE ARE ESTIMATED TO TAKE 9 MONTHS. WINTER CONDITIONS MAY AFFECT THIS SCHEDULE.

GENERAL:

. THIS PLAN IS INTENDED TO PROVIDE GUIDANCE AND INSTRUCTION TO THE CITY OF WORCESTER AND THE CONTRACTOR(S) IN THE PREVENTION OF EROSION AND SEDIMENTATION OFF SITE. THIS PLAN IS INTENDED TO ALLOW ANY CONDITIONS OF APPROVAL TO BE MORE SPECIFIC IN ADDRESSING ITEMS OF CONCERN. IF CONDITIONS BY THE CITY OF WORCESTER ARE IN CONFLICT WITH REQUIREMENTS AS SPECIFIED ON THE PLANS CONDITIONS AS SPECIFIED BY THE CITY OF WORCESTER SHALL SUPERSEDE THE REQUIREMENTS SPECIFIED ON THESE PLANS.

PRE-CONSTRUCTION:

- 1. AN EROSION CONTROL BARRIER (SEE BELOW) SHALL BE INSTALLED AS DEPICTED ON THE PLANS, BETWEEN THE AREAS TO BE DISTURBED AND RECEIVING DRAINAGE WAY AND STRUCTURES. THIS BARRIER SHALL REMAIN IN PLACE UNTIL ALL TRIBUTARY SURFACES HAVE BEEN FULLY STABILIZED. THE EROSION CONTROL BARRIERS AS SHOWN ON THE PLANS ARE THE MINIMUM PROTECTIVE MEASURES REQUIRED TO PROTECT THE ON AND OFF SITE DRAINAGE SYSTEMS.
- 2. THE CONTRACTOR SHALL ESTABLISH A STAGING AREA AS SHOWN ON THE PLAN FOR THE OVERNIGHT STORAGE OF EQUIPMENT AND STOCKPILING OF MATERIALS.
- 3. IN THE STAGING AREA, THE CONTRACTOR SHALL HAVE A STOCKPILE OF MATERIALS REQUIRED TO CONTROL EROSION ON-SITE TO BE USED TO SUPPLEMENT OR REPAIR EROSION CONTROL DEVICES. THESE MATERIALS SHALL INCLUDE, BUT ARE NOT LIMITED TO: HAY BALES, SILT FENCE AND CRUSHED STONE.
- 4. A TEMPORARY STONE CONSTRUCTION ENTRANCE IS REQUIRED TO PREVENT TRACKING OF SILT, MUD, ETC. ONTO EXISTING ROADS. THE STONE SHALL BE REPLACED REGULARLY AS WELL AS WHEN THE STONE IS SILT LADEN OR EQUIPMENT IS OBSERVED TO BE TRACKING SOIL ONTO THE ROADWAYS. SEE GENERAL CONSTRUCTION REQUIREMENTS, SEE NOTE #4 BELOW.
- 5. THE CONTRACTOR IS RESPONSIBLE FOR EROSION CONTROL ON & OFF SITE AND SHALL UTILIZE EROSION CONTROL MEASURES WHERE NEEDED, REGARDLESS OF WHETHER THE MEASURES ARE SPECIFIED HEREIN, ON THE PLAN OR IN ANY ORDER OF CONDITIONS.

PRELIMINARY SITE WORK:

- 1. MATERIAL REMOVED SHOULD BE STOCKPILED, SEPARATING THE TOPSOIL FOR FUTURE USE ON THE SITE OR IN A SECURED OFF SITE AREA APPROVED BY THE OWNER. EROSION CONTROLS SHALL BE UTILIZED ALONG THE DOWN SLOPE OF THE PILES IF THE PILES ARE TO REMAIN FOR MORE THAN THREE WEEKS.
- 2. IF INTENSE RAINFALL IS ANTICIPATED, THE INSTALLATION OF SUPPLEMENTAL HAY BALE DIKES, SILT FENCES, OR ARMORED DIKES SHALL BE UTILIZED.
- 3. IF THE SITE CONSTRUCTION OCCURS AT ANY TIME OTHER THAN THE APRIL DECEMBER CONSTRUCTION SEASON, ALL DRAINAGE SYSTEMS TEMPORARY OR PERMANENT SHALL MAINTAIN TO ENSURE ADEQUATE HYDRAULIC CAPACITY, AND DRAINING CHARACTERISTICS.

EROSION CONTROL MEASURES:

- 1. THE CONTRACTOR SHALL BE RESPONSIBLE FOR ENSURING THAT EROSION AND SEDIMENTATION ARE CONTROLLED. THIS PLAN SHALL BE SHALL BE ADAPTED TO FIT THE CONTRACTOR'S EQUIPMENT, WEATHER CONDITIONS, AND ANY CONDITIONS ISSUED BY THE CITY OF WORCESTER
- 2. THE MOST IMPORTANT ASPECTS OF CONTROLLING EROSION AND SEDIMENTATION ARE LIMITING THE EXTENT OF DISTURBANCE AND STABILIZING SURFACES AS SOON AS POSSIBLE. OF SECONDARY IMPORTANCE IN EROSION CONTROL IS THE LIMITING THE SIZE AND LENGTH OF THE TRIBUTARY DRAINAGE AREA WITHIN THE WORK SITE AND DRAINAGE STRUCTURES. THESE FUNDAMENTAL PRINCIPLES SHALL BE THE KEY FACTOR IN THE CONTRACTOR'S CONTROL OF EROSION ON THE SITE.
- 3. THE EXISTING SOIL CONDITIONS PROVIDE THE POTENTIAL OF RUNOFF TO OFF-SITE AREAS WITH EROSION POTENTIAL.
- 4. ALL DISTURBED SURFACES SHALL BE STABILIZED A MINIMUM OF 14 DAYS AFTER CONSTRUCTION IN ANY PORTION OF THE SITE HAS CEASED OR IS TEMPORARILY HALTED UNLESS ADDITIONAL CONSTRUCTION IS INTENDED TO BE INITIATED WITHIN 21 DAYS.
- 5. THE CONTRACTOR IS RESPONSIBLE FOR THE MAINTENANCE AND REPAIR OF ALL EROSION CONTROL DEVICES WITHIN THE LIMIT OF WORK. ALL EROSION CONTROL DEVICES SHALL BE REGULARLY INSPECTED. ANY SEDIMENTS REMOVED FROM THE CONTROL DEVICES SHALL BE DISPOSED OF.
- AT NO TIME SHALL SILT-LADEN WATER BE ALLOWED TO ENTER SENSITIVE AREAS (WETLANDS, OFF-SITE AREAS AND DRAINAGE SYSTEMS). ANY RUNOFF FROM DISTURBED SURFACES SHALL BE DIRECTED THROUGH SETTLING BASINS AND EROSION CONTROL BARRIERS PRIOR TO ENTERING ANY SENSITIVE AREAS.

GENERAL CONSTRUCTION REQUIREMENTS:

- 1. ANY REFUELING OF CONSTRUCTION VEHICLES AND EQUIPMENT SHALL NOT TAKE PLACE INSIDE OF A 100 FOOT BUFFER ZONE, NEAR THE ENTRANCE TO ANY DRAINAGE SYSTEM AND SHALL NOT BE CONDUCTED IN PROXIMITY TO SEDIMENTATION BASINS
- 2. NO ON-SITE DISPOSAL OF STUMPS, SOLID WASTE, INCLUDING CONSTRUCTION MATERIALS IS ALLOWED.
- 3. NO MATERIALS SHALL BE DISPOSED OF INTO THE WETLANDS, OR EXISTING/PROPOSED DRAINAGE SYSTEMS. ALL CONTRACTORS INCLUDING: CONCRETE SUPPLIERS, PAINTERS AND PLASTERERS, SHALL BE INFORMED THAT THE CLEANING OF EQUIPMENT IS PROHIBITED IN AREAS WHERE THE WASH-WATER WILL DRAIN DIRECTLY TO THE SITE DRAINAGE SYSTEMS.
- 4. THE CONTRACTOR SHALL UNDERTAKE ALL WORK TO LIMIT AIRBORNE SEDIMENTS, ONLY CLEAN, POTABLE WATER MAY BE USED TO CONTROL DUST.

LANDSCAPING:

- . LANDSCAPING SHALL OCCUR AS SOON AS POSSIBLE TO PROVIDE PERMANENT STABILIZATION OF DISTURBED SURFACES. 2. CONTRACTOR SHALL UTILIZE A VARIETY OF SLOPE STABILIZATION METHODS AND MATERIALS
- WHICH SHALL BE ADJUSTED TO THE SITE CONDITIONS. EROSION CONTROL BLANKETS OR MIRAFI MIRAMAT (OR SIMILAR PRODUCTS) SHALL BE AVAILABLE ON SITE.
- 3. IF THE SEASON OR ADVERSE WEATHER CONDITIONS DO NOT ALLOW THE ESTABLISHMENT OF VEGETATION, TEMPORARY MULCHING WITH HAY, TACKIFIED WOOD CHIPS OR OTHER METHODS SHALL BE PROVIDED.
- 4. ALL DISTURBED SURFACES TO BE PLANTED SHALL RECEIVE A MINIMUM OF 6" TOPSOIL SHALL BE PLACED AND ITS SURFACE SMOOTHED TO THE SPECIFIED GRADES.
- 5. ALL SLOPES OF 2.5:1 OR GREATER SHALL BE STABILIZED WITH EROSION CONTROL FABRIC. 6. TO ENSURE A DENSE, SUCCESSION GROWTH, SEED IS REQUIRED ON ALL DISTURBED SURFACES.
- GRAPHIC SCALE (IN FEET) 1 inch = 20 ft.8/21/24 | SITE PLAN AMENDMENT **|** 4/1/24 CITY COMMENTS

TITLE:

DATE

LEGEND:

EXISTING PROPERTY LINE

— —520 — EXISTING CONTOUR — HIGH

—518 — — EXISTING CONTOUR — LOW

——518 — PROPOSED CONTOUR – LOW

EXISTING DRAIN LINE

PROPOSED DRAIN LINE

----- EXISTING WATER LINE

EXISTING SEWER LINE

PROPOSED EROSION CONTROL

EXISTING CURB

PROPOSED CURB

EXISTING EDGE PAVEMENT

PROPOSED EDGE OF PAVEMENT

DEFINITIVE SITE PLAN 114 AUSTIN STREET WORCESTER, MASSACHUSETTS 01609

REVISION

PREPARED FOR:

POLAR VIEWS, LLC 89 WEST MAIN STREET UNIT 101 NORTHBOROUGH, MASSACHUSETTS 01532

PROPERTY OWNER:

POLAR VIEWS, LLC 89 WEST MAIN STREET UNIT 101 NORTHBOROUGH, MASSACHUSETTS 01532

J.M. GRENIER ASSOCIATES INC. 118 TURNPIKE ROAD SUITE 200 SOUTHBOROUGH, MASSACHUSETTS 01772

TELE NO.: (508) 845-2500 SCALE: 1" = 20'


FEBRUARY 5, 2024

jmgrenier@townisp.com

EROSION & SEDIMENTATION CONTROL PLAN


SHEET NO.: SHEET 7 OF 9


PROJECT NO.: G-684

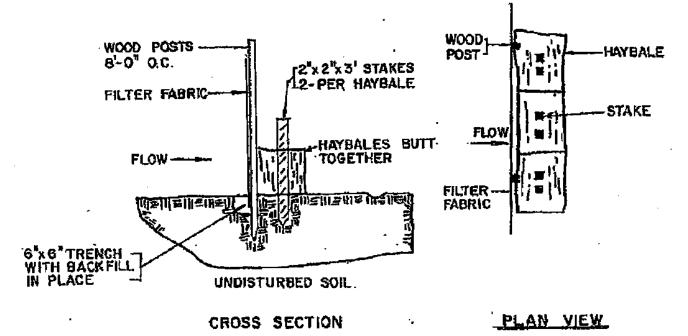

NOT TO SCALE

SILTATION CONTROL

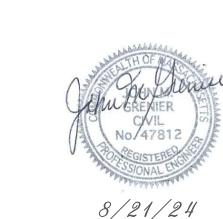

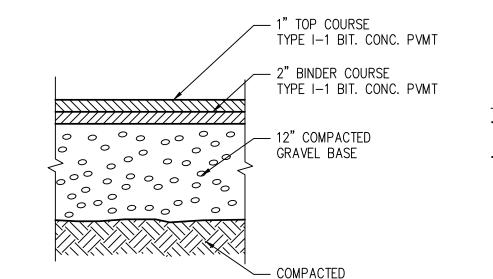

SLOPE 1/4" PER FT

2.5

1" TOP COURSE

2.5

1 DANS 1 PER FT

2" BINDER COURSE


1 DANS 1 PER FT

2.5


BASE

DRIVEWAY CROSS SECTION


SUBGRADE STANDARD BITUMINOUS CONCRETE PAVEMENT

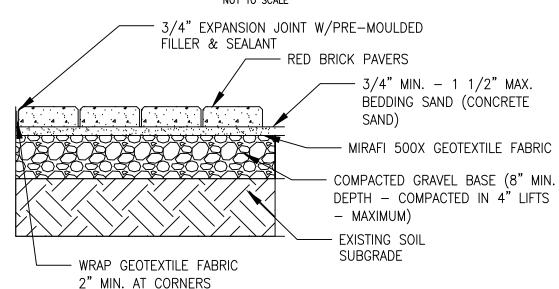


BRICK PAVER WALK

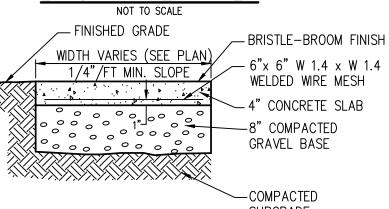


CEMENT CONCRETE PAD

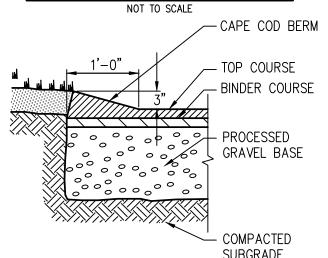


CAPE COD BERM

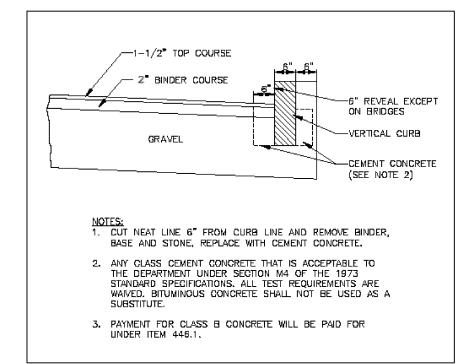

VERTICAL GRANITE CURB DETAIL NOT TO SCALE

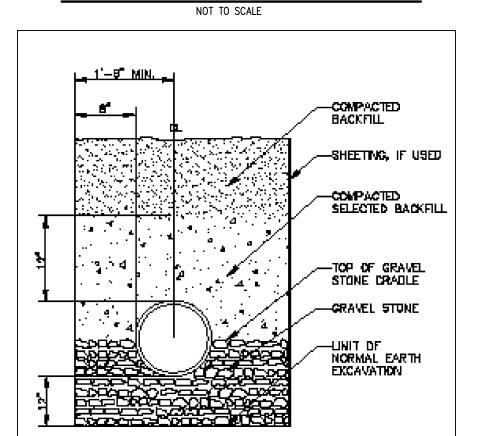


DRAIN TRENCH DETAIL

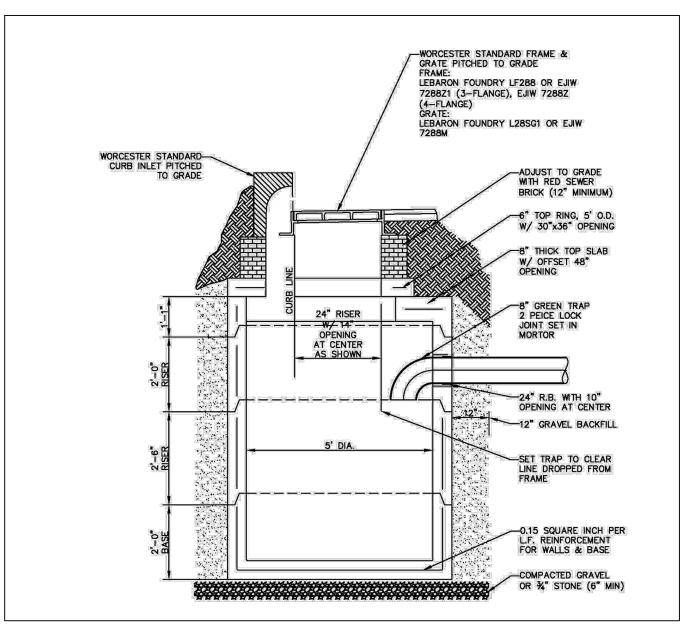


CATCH BASIN DETAIL

NOT TO SCALE

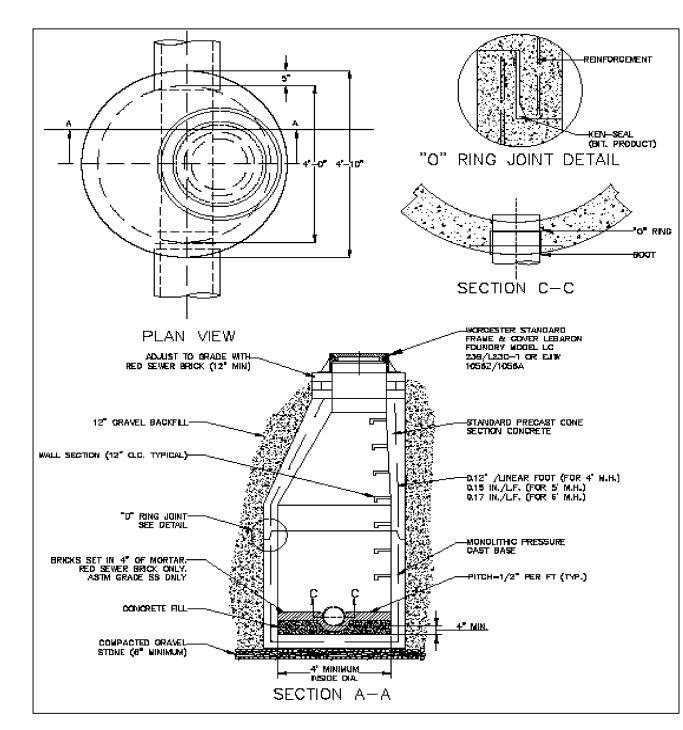

DRAIN MANHOLE DETAIL

NOT TO SCALE

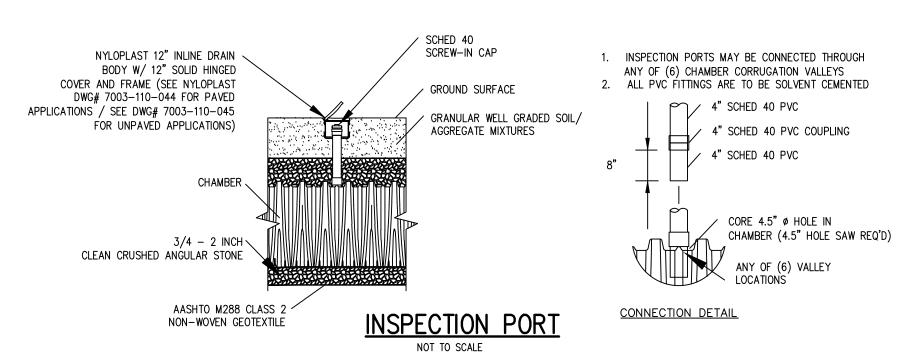


ACCEPTABLE FILL MATERIALS: STORMTECH CHAMBER SYSTEMS

MATERIAL LOCATION		DESCRIPTION	AASHTO M43 COMPACTION/DENSITY REQUIR DESIGNATION ¹	
(FILL MATERIAL FOR LAYER 'D' STARTS FROM THE TOP OF THE 'C' LAYER TO THE BOTTOM OF FLEXIBLE PAVEMENT OR UNPAVED FINISHED GRADE ABOVE. NOTE THAT PAVEMENT SUBBASE MAY BE PART OF THE 'D' LAYER.	ANY SOIL/ROCK MATERIALS, NATIVE SOILS, OR PER ENGINEER'S PLANS. CHECK PLANS FOR PAVEMENT SUBGRADE REQUIREMENTS.	N/A	PREPARE PER ENGINEER'S PLANS. PAVED INSTALLATIONS MAY HAVE STRINGENT MATERIAL AND PREPARATION REQUIREMENTS.
©	FILL MATERIAL FOR LAYER 'C' STARTS FROM THE TOP OF THE EMBEDMENT STONE ('B' LAYER) TO 24" [610 mm] ABOVE THE TOP OF THE CHAMBER. NOTE THAT PAVEMENT SUBBASE MAY BE A PART OF THIS LAYER.	GRANULAR WELL-GRADED SOIL/AGGREGATE MIXTURES, < 35% FINES. MOST PAVEMENT SUBBASE MATERIALS CAN BE USED IN LIEU OF THIS LAYER.	3, 357, 4, 467, 5, 56, 57, 6, 67, 68, 7, 78, 8, 89, 9, 10	BEGIN COMPACTION AFTER 24" [610 mm] OF MATERIAL OVER THE CHAMBERS IS REACHED. COMPACT ADDITIONAL LAYERS IN 6" [152 mm] LIFTS TO A MIN. 95% STANDARD PROCTOR DENSITY.
B	EMBEDMENT STONE SURROUNDING THE CHAMBERS FROM THE FOUNDATION STONE TO THE 'C' LAYER ABOVE.	CLEAN, CRUSHED, ANGULAR STONE, NOMINAL SIZE DISTRIBUTION BETWEEN 3/4 - 2 INCH [19 - 51 mm]	3, 357, 4, 467, 5, 56, 57	NO COMPACTION REQUIRED.
A	FOUNDATION STONE BELOW CHAMBERS FROM THE SUBGRADE UP TO THE FOOT (BOTTOM) OF THE CHAMBER.	CLEAN, CRUSHED, ANGULAR STONE, NOMINAL SIZE DISTRIBUTION BETWEEN 3/4 - 2 INCH [19 - 51 mm]	3, 35, 4, 467, 5, 56, 57	PLATE COMPACT OR ROLL TO ACHIEVE A 95% STANDARD PROCTOR DENSITY 2.


PLEASE NOTE:

1. THE LISTED AASHTO DESIGNATIONS ARE FOR GRADATIONS ONLY. THE STONE MUST ALSO BE CLEAN, CRUSHED, ANGULAR. FOR EXAMPLE, A SPECIFICATION FOR #4 STONE WOULD STATE: "CLEAN, CRUSHED, ANGULAR NO. 4 (AASHTO M43) STONE".

2. AS AN ALTERNATE TO PROCTOR TESTING AND FIELD DENSITY MEASUREMENTS ON OPEN GRADED STONE, STORMTECH COMPACTION REQUIREMENTS ARE MET FOR 'A' LOCATION MATERIALS

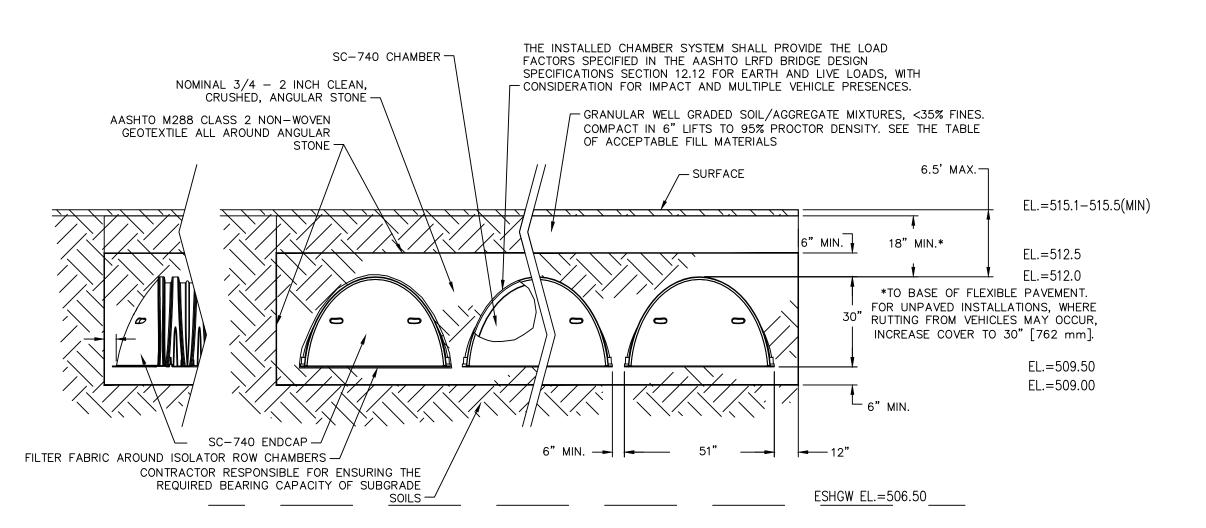

STORMTECH SC-740 INFILTRATION CHAMBERS (OR APPROVED EQUAL) CROSS-SECTION

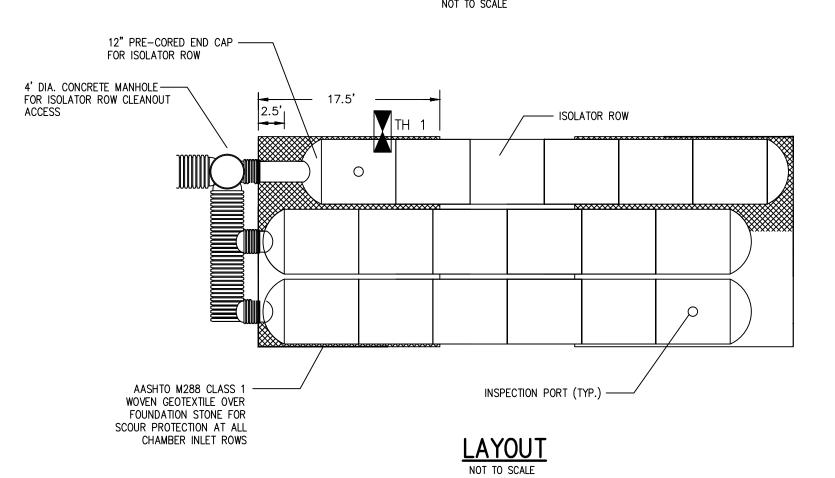

- 1. ALL DESIGN SPECIFICATIONS FOR STORMTECH SC-740 CHAMBERS SHALL BE IN ACCORDANCE WITH THE STORMTECH SC-740 DESIGN MANUAL.
- 2. THE INSTALLATION OF STORMTECH SC-740 CHAMBERS SHALL BE IN ACCORDANCE WITH THE LATEST STORMTECH SC-740 INSTALLATION INSTRUCTIONS.
- 3. THE CONTRACTOR IS ADVISED TO REVIEW AND UNDERSTAND THE INSTALLATION INSTRUCTIONS PRIOR TO BEGINNING SYSTEM INSTALLATION. CALL 1-888-892-2694 TO RECIEVE A COPY OF THE LATEST STORMTECH SC-740 INSTALLATION INSTRUCTIONS.
- 4. CHAMBERS SHALL MEET THE DESIGN REQUIREMENTS AND LOAD FACTORS SPECIFIED IN SECTION 12.12 OF THE LATEST EDITION OF THE AASHTO LRFD BRIDGE DESIGN SPECIFICATIONS.



2	-	8/21/24	SITE PLAN AMENDMENT
1		4/1/24	CITY COMMENTS
RE N	0.	DATE	REVISION

DEFINITIVE SITE PLAN
FOR

114 AUSTIN STREET WORCESTER, MASSACHUSETTS 01609

PREPARED FOR:

POLAR VIEWS, LLC 89 WEST MAIN STREET UNIT 101 NORTHBOROUGH, MASSACHUSETTS 01532

PROPERTY OWNER:

POLAR VIEWS, LLC
89 WEST MAIN STREET UNIT 101
NORTHBOROUGH, MASSACHUSETTS 01532

PREPARED BY:

J.M. GRENIER ASSOCIATES INC.

118 TURNPIKE ROAD SUITE 200

SOUTHBOROUGH, MASSACHUSETTS 01772

TELE NO.: (508) 845-2500

SCALE:

AS SHOWN


FEBRUARY 5, 2024

DETAIL PLAN 1/2


SHEET NO.: SHEET 8 OF 9

PROJECT NO.: G-684

jmgrenier@townisp.com

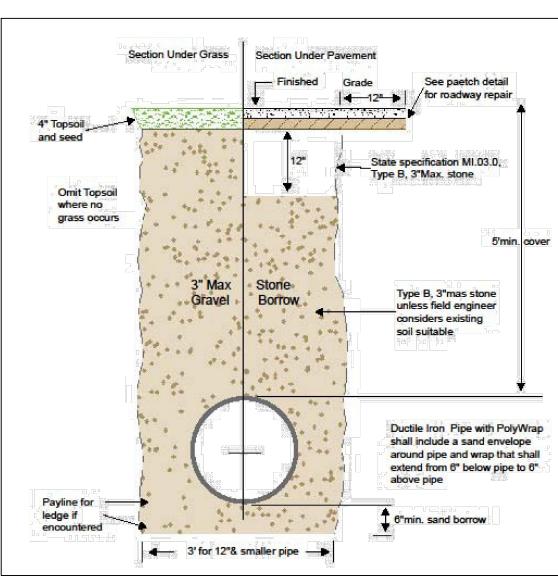


TYPICAL WATER TRENCH SECTION

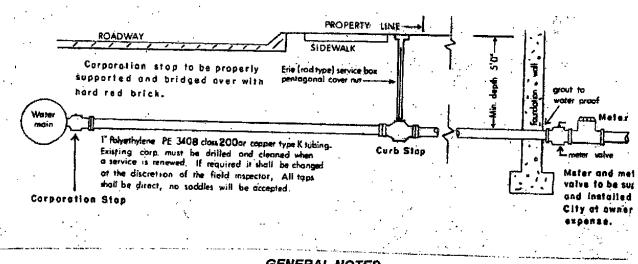

- **GENERAL NOTES**
- Fittings and valves shall be manufactured by Ford or approved equal. Corporations: Ford FB1000 c.c. thread by compression; Curb Stops: B44 series full port (comp. x comp.) All compression fittings used on polyethylene tubing shall be installed with solid, tubular stainless
- steel insert stiffeners.
- Sand shall be used for backfilling from a point 6 inches below the pipe to a point 12 inches above the pipe. The remaining backfill shall have no stones greater than 3 inches in their largest dimension. Before any excavation is done and any pipe is installed, permits shall be obtained from the Management Service office at 20 East Worcester St. and the Water Engineering office at 18 East Worcester St. All paving shall conform to City of Worcester D.P.W. standards. Services shall be flushed before activating to avoid meter clogging.
- Main valves are to be operated by the City only. Costs incurred in shutting down mains due to negligence of the Contractor as determined by the Field Inspector shall be paid by the Contractor. The Contractor shall inform the owner and the City wire inspector of proper grounding requirements
- pursuant to M.G.L. Chapter 165, Section 1C.
- On new services, in accordance with the Mass. Department of Environmental Protection Code 5 and its amendments, the water service shall be a minimum of 10 horizontal feet from the sewer
- 8. The Contractor shall furnish and completely install the service from corporation to the meter valves
- Upon installation of the service box, the Contractor shall operate the stop to the satisfaction of the Field Inspector prior to acceptance of the job.


WATER SERVICE DETAIL NOT TO SCALE

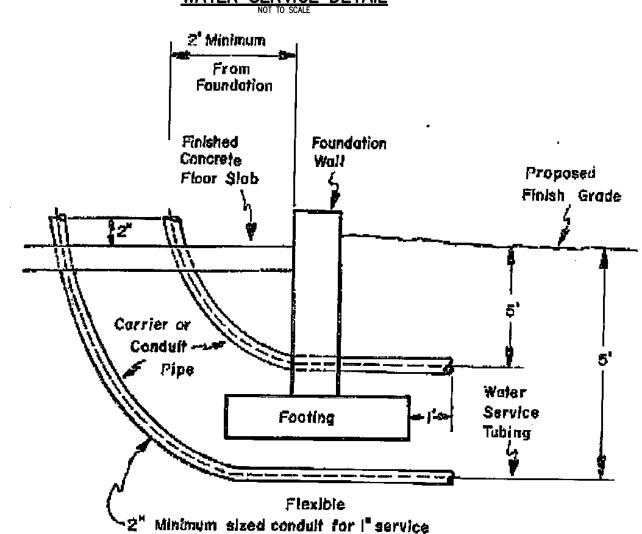


<u>GENERAL NOTES</u>

- When any water service 1-inch or less in size is to be installed under a concrete floor slab, the pipe shall be installed inside an approved conduit. This conduit shall be used as a sleeve or carrier pipe to receive the proposed value service tubing.
- The size of the conduit shall be at least twice the diameter of the water service pipe being
- The conduit shall be installed as shown in drawing W-8D which is part of these specifications.


WATER SERVICE ENTRANCE

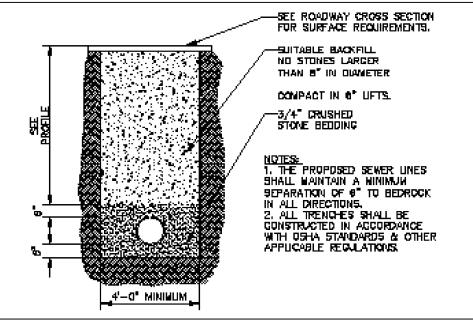


SEWER TRENCH DETAIL

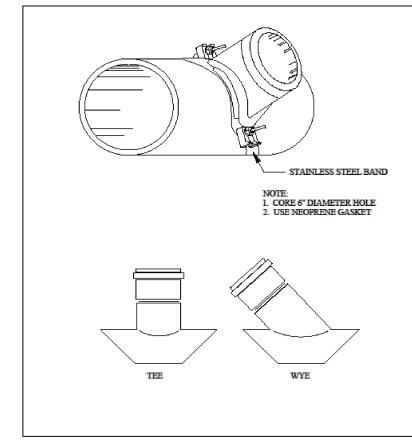

SEWER TEE & WYE CONNECTION

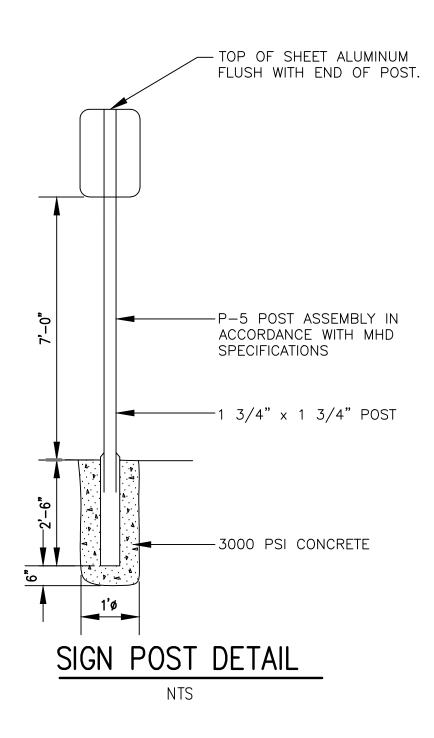

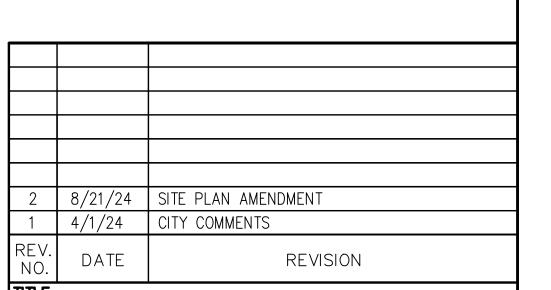

DEFINITIVE SITE PLAN

114 AUSTIN STREET WORCESTER, MASSACHUSETTS 01609

PREPARED FOR:

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PROPERTY OWNER:

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jmgrenier@townisp.com

PREPARED BY:

J.M. GRENIER ASSOCIATES INC. 118 TURNPIKE ROAD SUITE 200 SOUTHBOROUGH, MASSACHUSETTS 01772

TELE NO.: (508) 845-2500 SCALE:

FEBRUARY 5, 2024

DETAIL PLAN 2/2 SHEET NO.:

AS SHOWN

PROJECT NO.: SHEET 9 OF 9 G-684

